# **REQUEST FOR BIDS**

### ADDENDUM #2

**Questions and Clarifications** 

# Service Lane Renovation (General Contractor) IFB #FED2019-13

**TO:** Prospective Bidders

**FROM:** Martha Howarter, Director of Federal Programs

**DATE:** October 23, 2019

**SUBJECT:** Addendum No. 2 – Questions and Clarifications

The following is included as part of Addendum No.2 and supersedes the language/requirements set forth in the original "Request for Proposals".

## **ADDENDUM #2 – Questions and Clarifications**

#	Questions submitted or asked	Response from GPMTD
1	Do you have a tentative construction schedule or	Not at this time.
	a project duration?	
2	Do you have a plan for phasing and/or a	GC not required to provide temporary washing
	temporary wash area we need to include with	area.
	our bid?	
3	How long will Midwest Carwash Systems take	Refer to "General", #2 Farnsworth Section.
	to perform the install of the wash equipment?	
4	Was door 1B31-1 eliminated via addendum	Yes, refer to Addendum #1
	#1?	
5	Is the prep and painting of the floors an alternate	Yes, refer to the cover page of the drawings.
	or should we include that in our base bid?	
6	Do you anticipate us needing a fork truck for	Refer to "General", #1 Farnsworth Section
	unloading/staging the wash equipment?	
7	Whose responsibility is the compressed Air	Refer to Q1.1 & M1.1 for extent of Compressed
'	Piping and the process piping equipment?	air Work. General Contractor to coordinate
	1 iping and the process piping equipment:	scope of subcontractors.
8	Whose responsibility is the Demolition of the	Refer to QD1.1 & M1.1 for extent of Demolition
0	existing equipment including the water softener	Work. General Contractor to coordinate scope of
	& Car wash equipment?	subcontractors.

#	Questions submitted or asked	Response from GPMTD
9	equipment contract? There are no drawings that show the size of plumbing lines & there is no	Refer to InterClean Equipment shop drawings. All items labelled General Contractor (G) and Plumbing Contractor (P) for extent of Work. General Contractor to coordinate scope of subcontractors.
10	Whose responsibility is the Jet Flushing of the existing catch basins?	Refer to M1.1 for extent of Work. General Contractor to coordinate scope of subcontractors.

The following pages to Addendum No. 2 was prepared by Farnsworth Group containing thirteen (13) pages, one (1) drawing and one (1) specification related to the Service Lane Renovations.



Addendum Number: 02

**Project Name:** Service Lane Renovation

Project Number: 0180459.05

Containing: 13 Pages; 1 Drawings; 1 Specifications

This addendum amends the drawings and specifications of the above reference project and is hereby incorporated into the contract documents as part thereof. Bidders must acknowledge receipt of this Addendum in the space provided on the Bid Form. **FAILURE TO DO SO MAY SUBJECT BIDDER TO DISQUALIFICATION**.

#### General:

- 1. The General Contractor shall provide 5,000lbs forklift capacity with extended forks for unloading the wash equipment.
- 2. The installation of the wash equipment by Midwest Carwash Systems will take approximately 2 weeks and another 3-5 days for start-up and training.
- 3. Overhead coiling door operating speeds slower than specified in section 08 3323 will not be accepted.
- 4. Revised equipment submittal from InterClean provided for reference.

#### **Specifications:**

- 1. ADD the attached specification: 08 7100 DOOR HARDWARE.
- 2. Owner's keying system is Medeco by Cops, Inc. Contractor to provide twenty (20) keys.

#### **Drawings:**

1. A7.1 Door Schedule, Elevations, and Details: Revised door hardware schedule.

Bids are Due: October 31, 2019 / 2:00 PM local time at GPMTD PROCUREMENT, 2105 NE JEFFERSON AVENUE, PEORIA, ILLINOIS 61603-3535.

#### **Issued By:**

FARNSWORTH GROUP, INC. Douglas Draeger Project Architect

#### **Attachments:**

08 7100 Door Hardware (5 pages), A7.1 (1 sheet), Revised InterClean Equipment submittal (12 pages)

#### SECTION 08710 - DOOR HARDWARE

#### PART 1 - GENERAL

#### 1.1 SUMMARY

- A. This Section includes the following:
  - 1. Commercial door hardware.
  - 2. Cylinders for doors specified in other Sections.

#### 1.2 SUBMITTALS

- A. Product Data: For each product indicated.
- B. Shop Drawings: Include details of electrified door hardware and wiring diagrams.
- C. Samples: For each exposed finish.
- D. Door Hardware Schedule: Organized into door hardware sets indicating type, style, function, size, label, hand, manufacturer, fasteners, location, and finish of each door hardware item. Include description of each electrified door hardware function, including sequence of operation.

PROJECT NO.: 0180459.05

- E. Keying Schedule: Detail Owner's final keying instructions for locks.
- F. Product certificates.

#### 1.3 QUALITY ASSURANCE

- A. Supplier Qualifications: Person who is or employs a qualified DHI Architectural Hardware Consultant.
- B. Source Limitations: Obtain electrified door hardware from same manufacturer as mechanical door hardware, unless otherwise indicated. Manufacturers that are listed to perform electrical modifications, by a testing and inspecting agency acceptable to authorities having jurisdiction, are acceptable.
- C. Keying Conference: Conduct conference at Project site. Incorporate keying conference decisions into final keying schedule.
- D. Pre-Installation Conference: Conduct conference at Project site.
- E. Keys: Deliver keys to Owner by registered mail.
- F. Templates: Obtain and distribute templates for doors, frames, and other work specified to be factory prepared for installing door hardware.
- G. Standards: Comply with BHMA A156 series standards, Grade 1.
- H. Certified Products: Provide door hardware that is listed in BHMA directory of certified products.

#### 1.4 WARRANTY

A. Special Warranty: Manufacturer's standard form in which manufacturer agrees to repair or replace components of door hardware that fails in materials or workmanship within warranty period from date of Substantial Completion.

PROJECT NO.: 0180459.05

- 1. Warranty Period for Manual Closers: 10 years.
- 2. Warranty Period for Exit Devices: 10 years.
- 3. Warranty Period for Locks: 10 years.
- 4. All other hardware one year.

#### PART 2 - PRODUCTS

#### 2.1 MANUFACTURERS

- A. Product: Subject to compliance with requirements, provide the product named for each door hardware item indicated in Door Hardware Sets.
- B. Basis-of-Design Product: Product named for each door hardware item indicated in Door Hardware Sets establishes the basis of design. Provide either the named product or a comparable product by one of the manufacturers specified for each type of hardware item.
- C. Manufacturers Used in the specification:

<u>Products</u>	Manufacture Specified	Acceptable Equals
Hinges	lves	Hager, Stanley
Continuous Hinges	lves	Roton, Select
Locksets	Falcon T	Schlage ND, BEST 9K, Sargent 10- Line
Closers	Falcon SC71A	LCN 4050, Norton, Sargent
Cylinders	Match Existing: Medeco	

#### 2.2 DOOR HARDWARE

A. Scheduled Door Hardware: Provide door hardware according to Door Hardware Sets at the end of Part 3. Manufacturers' names are abbreviated.

#### 2.3 HINGES

- A. General: Except for hinges and pivots to be installed entirely (both leaves) into wood doors and frames, provide only template-produced units.
- B. Hinge Base Metal: Unless otherwise indicated, provide the following:
  - 1. Exterior Hinges: Stainless steel, with stainless-steel pin.
  - 2. Interior Hinges: Steel, with steel pin.

- 3. Hinges for Fire-Rated Assemblies: Steel, with steel pin.
- C. Non-removable Pins: Provide set screw in hinge barrel that prevents removal of pin while door is closed; for out-swinging exterior doors.
- D. Screws: Phillips flat-head screws; screw heads finished to match surface of hinges.
- E. Metal Doors and Frames: Machine screws (drilled and tapped holes).

#### 2.4 MECHANICAL LOCKS AND LATCHES

#### A. Cylindrical Locks:

1. Locks shall be ANSI A156.2, Series 4000 Grade 1 UL Listed for 3-hour doors. Manufactured from heavy gauge cold rolled steel mechanisms that are corrosion treated for normal conditions.

PROJECT NO.: 0180459.05

- 2. Locks to have standard 2-3/4" backset with a full 1/2" reversible dead latch. Thru-bolted mounting post for positive interlock to the door with concealed mounting screws.
- 3. Lever trim shall be pressure cast zinc to match finishes. The design specified, with 3-7/16" diameter roses. Trim shall be applied by "no exposed screws".

#### 2.5 CLOSERS

- A. Surface-Mounted Closers:
- B. Spring power shall be continuously adjustable over the full range of closer sizes, and allow for reduced opening force for the physically handicapped. Hydraulic regulation shall be by tamper-proof, non-critical valves. Closers shall have separate adjustment for latch speed, general speed, and back check.
- C. All closers will not be seen on the public side or hallway side of the door. The appropriate drop plate or mounting plates will be used as conditions dictate.

#### 2.6 STOPS AND HOLDERS

- A. Stops and Holders: Provide floor stops for doors, unless wall or other type stops are scheduled or indicated. Do not mount floor stops where they will impede traffic. Where floor or wall stops are not appropriate, provide overhead holders.
- B. Silencers for Door Frames: Neoprene or rubber; fabricated for drilled-in application to frame.

#### 2.7 DOOR GASKETING AND THRESHOLDS

A. Door Gasketing: Provide continuous weather-strip gasketing on exterior doors and provide smoke, light, or sound gasketing on interior doors where indicated or scheduled. Provide non-corrosive fasteners for exterior applications and elsewhere as indicated.

#### 2.8 CYLINDERS, KEYING, AND STRIKES

A. Cylinders: Tumbler type, constructed from brass or bronze, stainless steel, or nickel silver.

- B. Keying System: Match existing: Medeco
- C. Keys: Provide twenty (20) keys.

#### 2.9 FABRICATION

A. Base Metals: Furnish metals of a quality equal to or greater than that of specified door hardware units and BHMA A156.18 for finishes. Do not furnish manufacturer's standard materials if different from specified standard.

PROJECT NO.: 0180459.05

- B. Fasteners: Phillips flat-head screws with finished heads to match surface of door hardware, unless otherwise indicated. Provide steel machine or wood screws or steel through bolts for fire-rated applications.
- C. Spacers or Sex Bolts: For through bolting of hollow metal doors.
- D. Fasteners for Wood Doors: Comply with requirements of DHI WDHS.2, "Recommended Fasteners for Wood Doors."
- E. Finishes: Comply with BHMA A156.18.

#### PART 3 - EXECUTION

#### 3.1 INSTALLATION

- A. Examine doors and frames for compliance with requirements for installation tolerances, labeled fire door assembly construction, wall and floor construction, and other conditions affecting performance. Examine roughing-in for electrical power systems to verify actual locations of wiring connections before electrified door hardware installation.
- B. Steel Door and Frame Preparation: Comply with DHI A115 series. Drill and tap doors and frames for surface-applied hardware according to SDI 107.
- C. Wood Door Preparation: Comply with DHI A115-W series.
- D. Mounting Heights: Comply with the following requirements, unless otherwise indicated:
  - 1. Standard Steel Doors and Frames: DHI's "Recommended Locations for Architectural Hardware for Standard Steel Doors and Frames."
  - 2. Custom Steel Doors and Frames: DHI's "Recommended Locations for Builders' Hardware for Custom Steel Doors and Frames."
  - 3. Wood Doors: DHI WDHS.3, "Recommended Locations for Architectural Hardware for Wood Flush Doors."
- E. Adjust and reinforce attachment substrates as necessary for proper installation and operation. Drill and countersink units that are not factory prepared for anchorage fasteners. Space fasteners and anchors according to industry standards.
  - 1. Thresholds: Set thresholds for exterior and acoustical doors in full bed of sealant complying with requirements specified in Division 7 Section "Joint Sealants."

- F. Adjust door control devices to compensate for final operation of heating and ventilating equipment and to comply with accessibility requirements.
  - 1. Door Closers: Adjust sweep period so that from an open position of 70 degrees, the door will take at least three seconds to move to a point 3 inches (75 mm) from the latch, measured to the leading edge of the door.

PROJECT NO.: 0180459.05

#### 3.2 FIELD QUALITY CONTROL

A. Inspections: Contractor to engage a qualified independent Architectural Hardware Consultant to perform inspections and to prepare inspection reports. Provide report to architect.

#### 3.3 DOOR HARDWARE SETS

#### Hardware Set # 1

1B35-1, 1B29-3, 1B29-4

QTY		DESCRIPTION	CATALOG NUMBER	FINISH	MFR
3	EA	HINGE	5BB1 4.5 X 4.5	652	IVE
1	EA	STOREROOM LOCK	MA581 LD DG	626	FAL
1	EA	SURFACE CLOSER	SC71 RW/PA	689	FAL
1	EA	KICK PLATE	8400 10" X 2" LDW B-CS	630	IVE
1	EA	WALL STOP	WS401/402CVX	626	IVE
3	EA	SILENCER	SR64	GRY	IVE


One Medeco cylinder by Cops, Inc.

#### Hardware Set # 2

1B29-2, 1B30-1, 1B33-1

Q	ΓΥ	DESCRIPTION	CATALOG NUMBER	FINISH	MFR
3	EA	HINGE	5BB1 4.5 X 4.5	652	IVE
1	EA	PASSAGE LEVER	T101 DANE	626	FAL
1	EA	SURFACE CLOSER	SC71 RW/PA	689	FAL
1	EA	KICK PLATE	8400 10" X 2" LDW B-CS	630	IVE
1	EA	WALL STOP	WS401/402CVX	626	IVE
3	EA	SILENCER	SR64	GRY	IVE

#### **END OF SECTION 08 7100**

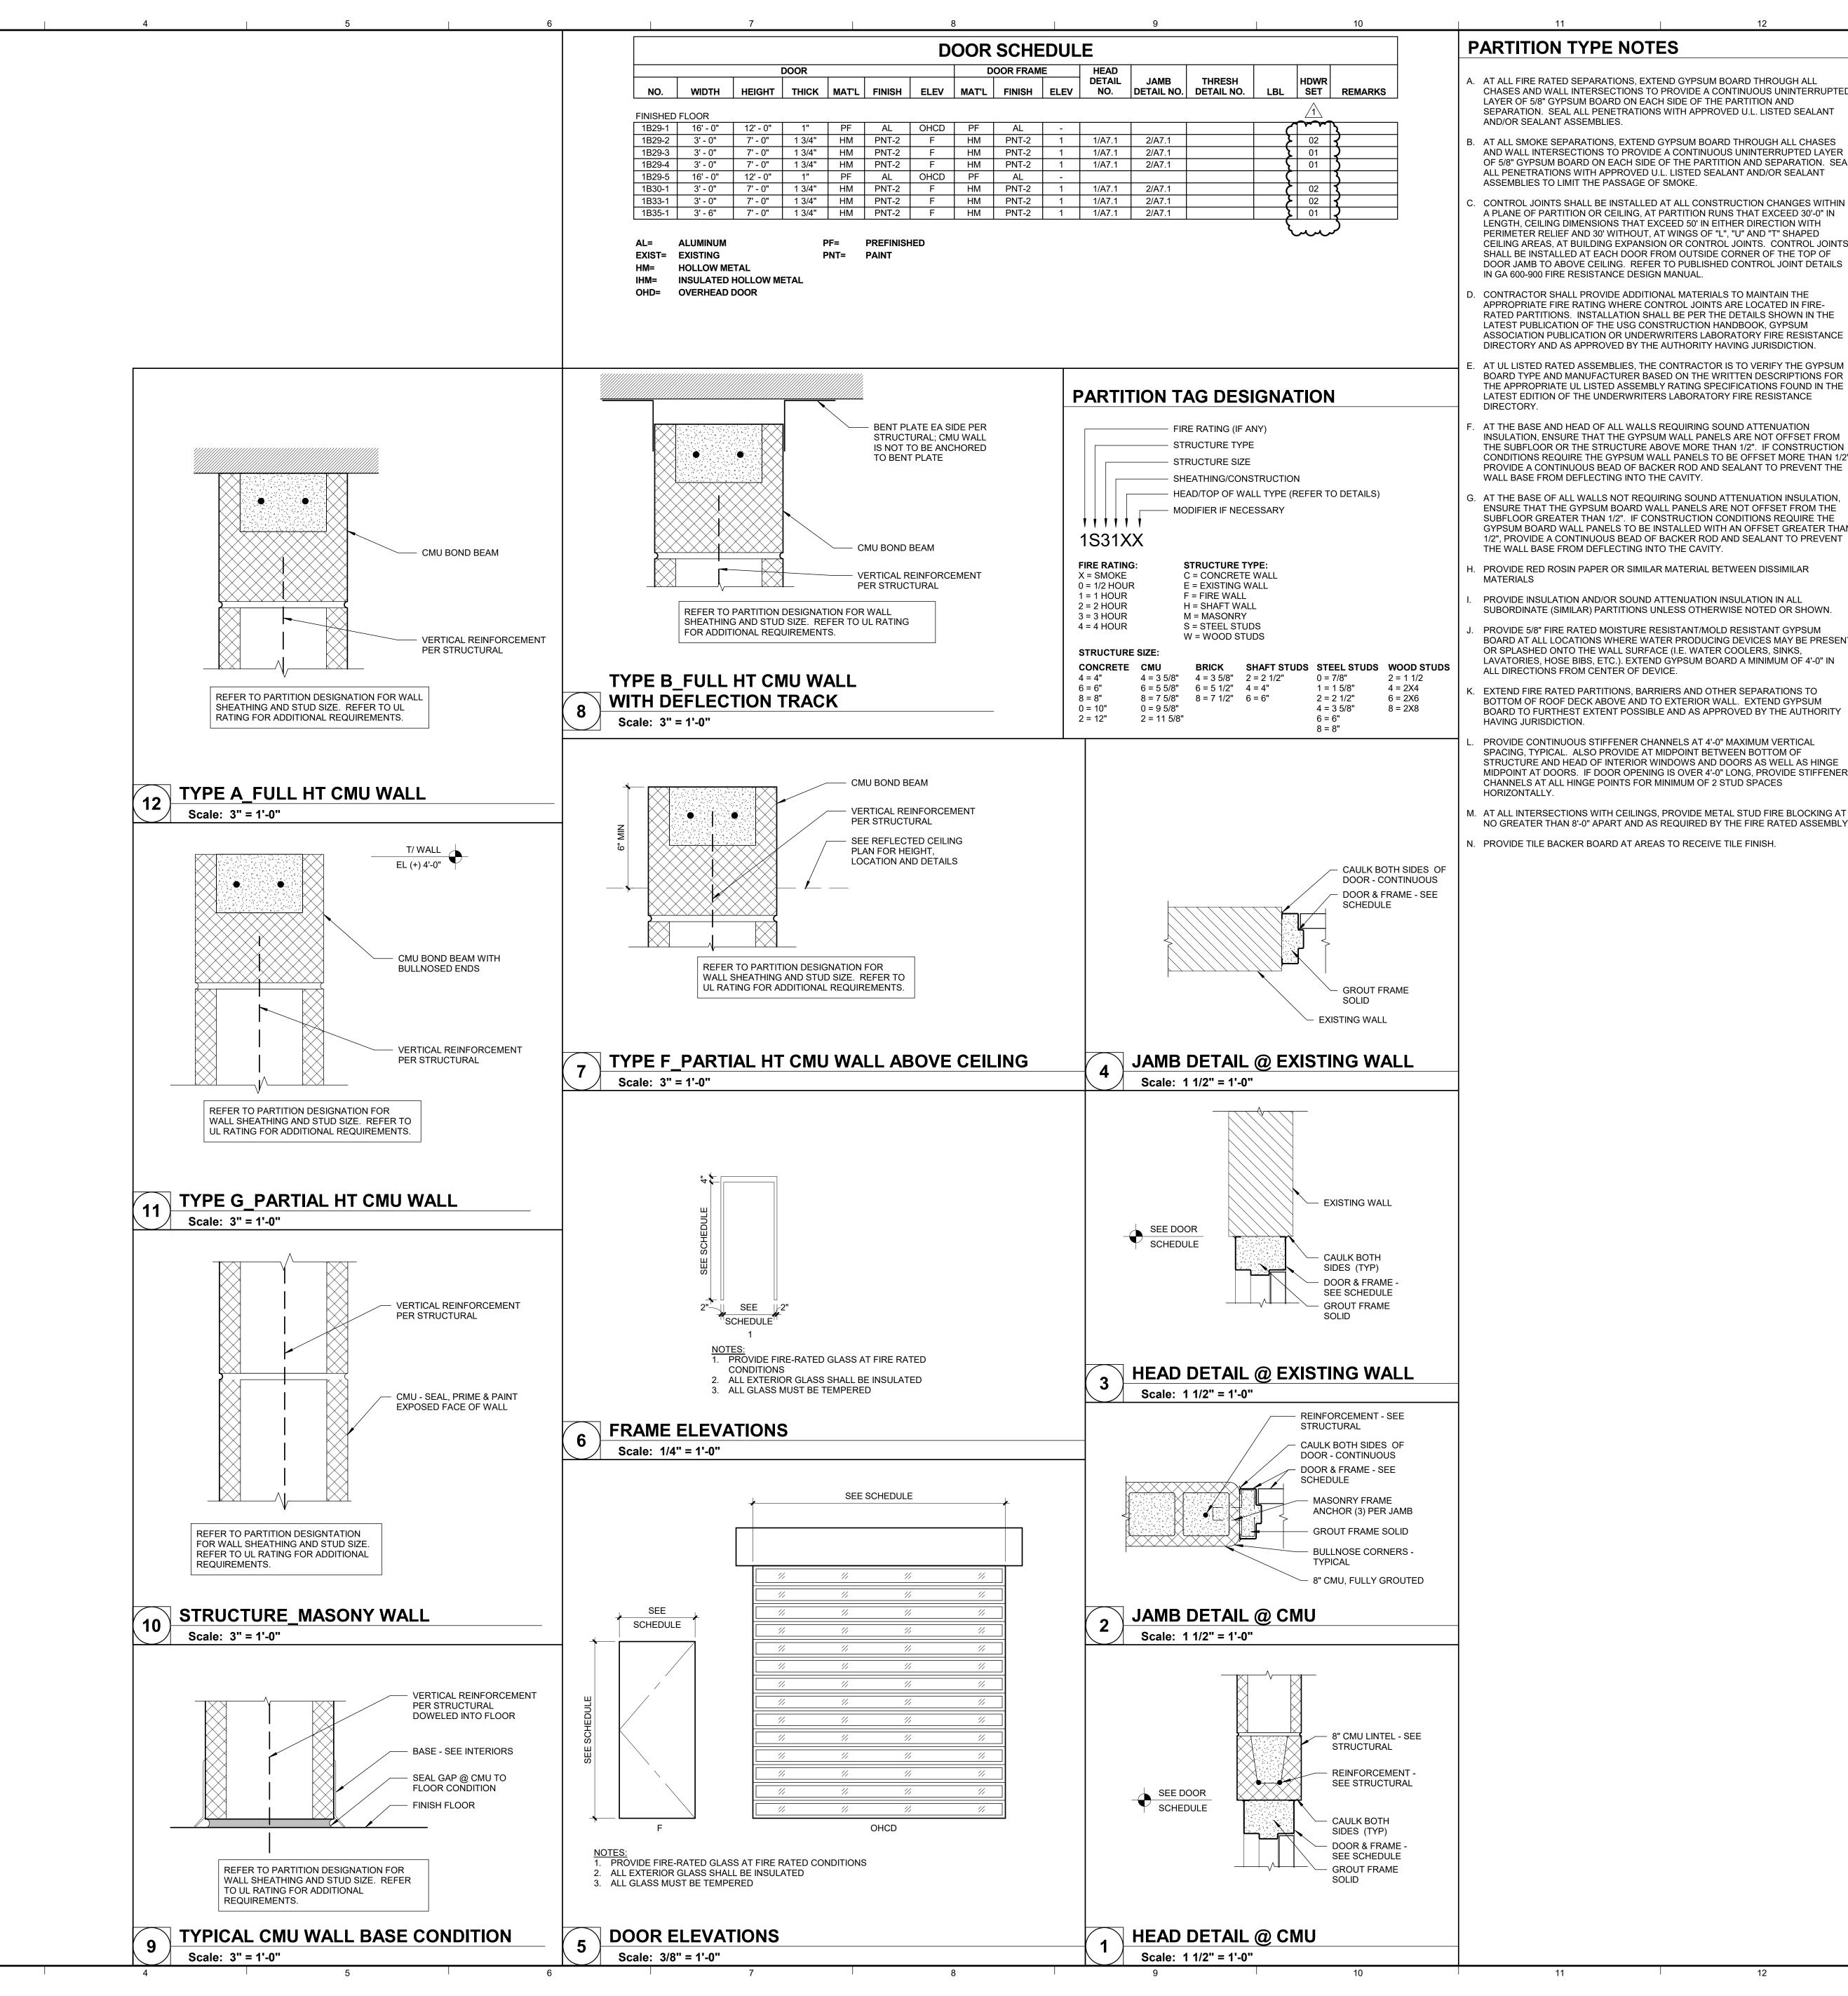



- . AT ALL FIRE RATED SEPARATIONS, EXTEND GYPSUM BOARD THROUGH ALL CHASES AND WALL INTERSECTIONS TO PROVIDE A CONTINUOUS UNINTERRUPTED LAYER OF 5/8" GYPSUM BOARD ON EACH SIDE OF THE PARTITION AND SEPARATION. SEAL ALL PENETRATIONS WITH APPROVED U.L. LISTED SEALANT
- B. AT ALL SMOKE SEPARATIONS, EXTEND GYPSUM BOARD THROUGH ALL CHASES AND WALL INTERSECTIONS TO PROVIDE A CONTINUOUS UNINTERRUPTED LAYER OF 5/8" GYPSUM BOARD ON EACH SIDE OF THE PARTITION AND SEPARATION. SEAL ALL PENETRATIONS WITH APPROVED U.L. LISTED SEALANT AND/OR SEALANT
- . CONTROL JOINTS SHALL BE INSTALLED AT ALL CONSTRUCTION CHANGES WITHIN A PLANE OF PARTITION OR CEILING, AT PARTITION RUNS THAT EXCEED 30'-0" IN LENGTH, CEILING DIMENSIONS THAT EXCEED 50' IN EITHER DIRECTION WITH PERIMETER RELIEF AND 30' WITHOUT, AT WINGS OF "L", "U" AND "T" SHAPED CEILING AREAS, AT BUILDING EXPANSION OR CONTROL JOINTS. CONTROL JOINTS SHALL BE INSTALLED AT EACH DOOR FROM OUTSIDE CORNER OF THE TOP OF DOOR JAMB TO ABOVE CEILING. REFER TO PUBLISHED CONTROL JOINT DETAILS
- . CONTRACTOR SHALL PROVIDE ADDITIONAL MATERIALS TO MAINTAIN THE APPROPRIATE FIRE RATING WHERE CONTROL JOINTS ARE LOCATED IN FIRE-RATED PARTITIONS. INSTALLATION SHALL BE PER THE DETAILS SHOWN IN THE LATEST PUBLICATION OF THE USG CONSTRUCTION HANDBOOK, GYPSUM ASSOCIATION PUBLICATION OR UNDERWRITERS LABORATORY FIRE RESISTANCE DIRECTORY AND AS APPROVED BY THE AUTHORITY HAVING JURISDICTION.
- AT UL LISTED RATED ASSEMBLIES, THE CONTRACTOR IS TO VERIFY THE GYPSUM BOARD TYPE AND MANUFACTURER BASED ON THE WRITTEN DESCRIPTIONS FOR THE APPROPRIATE UL LISTED ASSEMBLY RATING SPECIFICATIONS FOUND IN THE LATEST EDITION OF THE UNDERWRITERS LABORATORY FIRE RESISTANCE
- AT THE BASE AND HEAD OF ALL WALLS REQUIRING SOUND ATTENUATION INSULATION, ENSURE THAT THE GYPSUM WALL PANELS ARE NOT OFFSET FROM THE SUBFLOOR OR THE STRUCTURE ABOVE MORE THAN 1/2". IF CONSTRUCTION CONDITIONS REQUIRE THE GYPSUM WALL PANELS TO BE OFFSET MORE THAN 1/2". PROVIDE A CONTINUOUS BEAD OF BACKER ROD AND SEALANT TO PREVENT THE
- ENSURE THAT THE GYPSUM BOARD WALL PANELS ARE NOT OFFSET FROM THE SUBFLOOR GREATER THAN 1/2". IF CONSTRUCTION CONDITIONS REQUIRE THE GYPSUM BOARD WALL PANELS TO BE INSTALLED WITH AN OFFSET GREATER THAN 1/2", PROVIDE A CONTINUOUS BEAD OF BACKER ROD AND SEALANT TO PREVENT THE WALL BASE FROM DEFLECTING INTO THE CAVITY.
- . PROVIDE RED ROSIN PAPER OR SIMILAR MATERIAL BETWEEN DISSIMILAR
- PROVIDE INSULATION AND/OR SOUND ATTENUATION INSULATION IN ALL SUBORDINATE (SIMILAR) PARTITIONS UNLESS OTHERWISE NOTED OR SHOWN.
- PROVIDE 5/8" FIRE RATED MOISTURE RESISTANT/MOLD RESISTANT GYPSUM BOARD AT ALL LOCATIONS WHERE WATER PRODUCING DEVICES MAY BE PRESENT OR SPLASHED ONTO THE WALL SURFACE (I.E. WATER COOLERS, SINKS, LAVATORIES, HOSE BIBS, ETC.). EXTEND GYPSUM BOARD A MINIMUM OF 4'-0" IN ALL DIRECTIONS FROM CENTER OF DEVICE.
- BOTTOM OF ROOF DECK ABOVE AND TO EXTERIOR WALL. EXTEND GYPSUM BOARD TO FURTHEST EXTENT POSSIBLE AND AS APPROVED BY THE AUTHORITY
- SPACING, TYPICAL. ALSO PROVIDE AT MIDPOINT BETWEEN BOTTOM OF STRUCTURE AND HEAD OF INTERIOR WINDOWS AND DOORS AS WELL AS HINGE MIDPOINT AT DOORS. IF DOOR OPENING IS OVER 4'-0" LONG, PROVIDE STIFFENER CHANNELS AT ALL HINGE POINTS FOR MINIMUM OF 2 STUD SPACES
- NO GREATER THAN 8'-0" APART AND AS REQUIRED BY THE FIRE RATED ASSEMBLY



100 WALNUT STREET, SUITE 200 PEORIA, ILLINOIS 61602 (309) 689-9888 / info@f-w.com www.f-w.com Engineers | Architects | Surveyors | Scientists



# DATE: DESCRIPTION: 10/23/2019 ADDENDUM #2

> **BID SET** 10/1/2019

**Greater Peoria Mass Transit District** 

CityLink Service Bay Remodel

2105 NE Jefferson Street Peoria, IL 61603

DATE:	10/1/2019
DESIGNED:	DRD
DRAWN:	TAW
REVIEWED:	EJB

DOOR SCHEDULE,

**ELEVATIONS AND** DETAILS

PROJECT NO.:

DRAWING NUMBER	DESCRIPTION
#LY19-074-00	DRAWING INDEX
#LY19-074-01	3D VIEW
#LY19-074-02	PLAN VIEW
#LY19-074-03	SIDE VIEW
#LY19-074-04	END VIEW
#LY19-074-05	PLUMBING SCHEMATIC
#LY19-074-06A	ELECTRICAL LAYOUT 1 OF 2
#LY19-074-06B	ELECTRICAL LAYOUT 2 OF 2
#LY19-074-07	EQUIPMENT LAYOUT
#LY19-074-08	PIPING 3D
#LY19-074-09	CONCRETE LAYOUT
#LY19-074-10	UNDERGROUND CONDUITS

	System List	
Prefix	Description	Prefi
ACS	Air Compressed System	ACD
CPS	Customer Provided System	ALK
CSD	Control System Device	AC
DES	Dedicated Electrical System	BL
DET	Detergent System	BR
FWS	Fresh Water System	CD
PHS	PH Control System	DSP
ROS	Reverse Osmosis (RO) System	F
RWS	Reclaim Water System	МСР
WCS	Wheel/Chassis System	MDP
		OS
		Р
		PCP
		SCP
		TK
		WS

	Component List		Device List
fix	Description	Prefix	Description
)	Acid Chemical	Al	Analog Inupt
<	Alkaline Chemical	AO	Analog Outupt
	Air Compressor	AU	Air Condition Unit
	Blower	BV	Ball Valve
	Brush	BFV	Butterfly Valve
	Customer Device	CAV	Co-Ax Valve
)	Distributed I/O Panel	CXV	Customer Device
	Filter	CV	Check Valve
Р	Main Control Panel	DI	Digital Input
Р	Main Distribution Panel	DO	Digital Output
	Oil Skimmer	ES	Emergency Stop
	Pump	FI	Flow Rate Indicator
)	Pneumatic Control Panel	FT	Flow Rate Transmitter
)	Slave Control Panel	FIT	Flow Rate Transmitter w/Indicat
	Tank	FV	Flow Regulator
	Water Softener	НМІ	Touchscreen

HRN

LSH

LSLL

LS0

SSW

Water Heater

P&ID SY	MBOL
---------	------

FLANGE

UNION

CENTRIFUGAL PUMP

Customer Device	ANGLE VALVE	CINICIN	
Check Valve			SUBMERSIBLE PUMP
Digital Input	<u>N</u>		
Digital Output	ANTI-FREEZE VALVE	FLOOR DRAIN	Π "
Emergency Stop	N-4		
Flow Rate Indicator	BALL VALVE		日本 日
Flow Rate Transmitter		AIR VENT	
Flow Rate Transmitter w/Indicator			
Flow Regulator	BUTTERFLY VALVE	AIR VENT WITH SCREEN	METERING PUMP
Touchscreen	N I		
	CHECK VALVE		
Audible Alarm/Horn Level Indicator	CHECK VALVE	FLEXIBLE HOSE	
		<u></u>	
Level Transmitter			DIAPHRAGM PUMP
Level Transmitter w/Indicator	ELE/PNE CONTROL VALVE	AIR GAP	
High High Level Alarm Sensor			
High Level Alarm Sensor		$\longleftrightarrow$	
Low Level Alarm Sensor	GATE VALVE	FILTER	GEAR PUMP
Low Low Level Alarm Sensor			
Overflow Level Sensor	GLOBE VALVE		(5プ
Motor Run Status	$\sim$	Air Filter	AIR BLOWER
Push Button			$\overline{M}$
Pneumatic Control Valve	FLOAT VALVE	$\triangleright$	
Ph Sensor	M	REDUCER	MOTOR
Pressure Indicator			
Pressure Transmitter w/Indicator	MOTOR VALVE		
Pressure Transmitter	S	VENTURI	
Pressure Regulator			
Speed Display	SOLENOID VALVE		
Select Switch	8	PRESSURE REGULATOR	
Stobe Light/Visual Annuciator	\\$\		
Solenoid Valve	PRESSURE RELIEF VALVE		
Temperature Indicator		T FYDANGION FANK	
Temperature Transmitter/w Indicator	<mark>4</mark>	EXPANSION TANK	
Temperature Transmitter	Y-STRAINER W/VALVE	T-°	
Traffric Light, Red/Green	]   <b>N</b> ⊗∕1	L <u>'</u> _  THERMOSTAT	
Wireless Control Device	MIXING VALVE	TILINIOSTAT	
Photoelectric Source Sensor			
Photoelectric Receiver Sensor		-100H-1-H00H	
Limit Switch	W GROOVED COUPLING	BACKFLOW PREVENTER	
Proximity Sensor	GROOVED COOPEING		
Transformer			
Motor Start/Stop Switch	FLOW RESTRICTOR	FILTER REGULATOR LUBRICATOR	
,	, FLOW RESTRICTOR	LUBRICATOR	
	KNIFE VALVE	FILTER REGULATOR	
	ı		İ


 $\bowtie$ 3-WAY VALVE

# | N T E R CLEAN

709 James L Hart Parkway Ypsilanti, MI 48197

Web Site: www.interclean.com E-mail: sales@interclean.com Phone: (734) 961-3300 (800) 468-3725 Fax: (734) 961-0092

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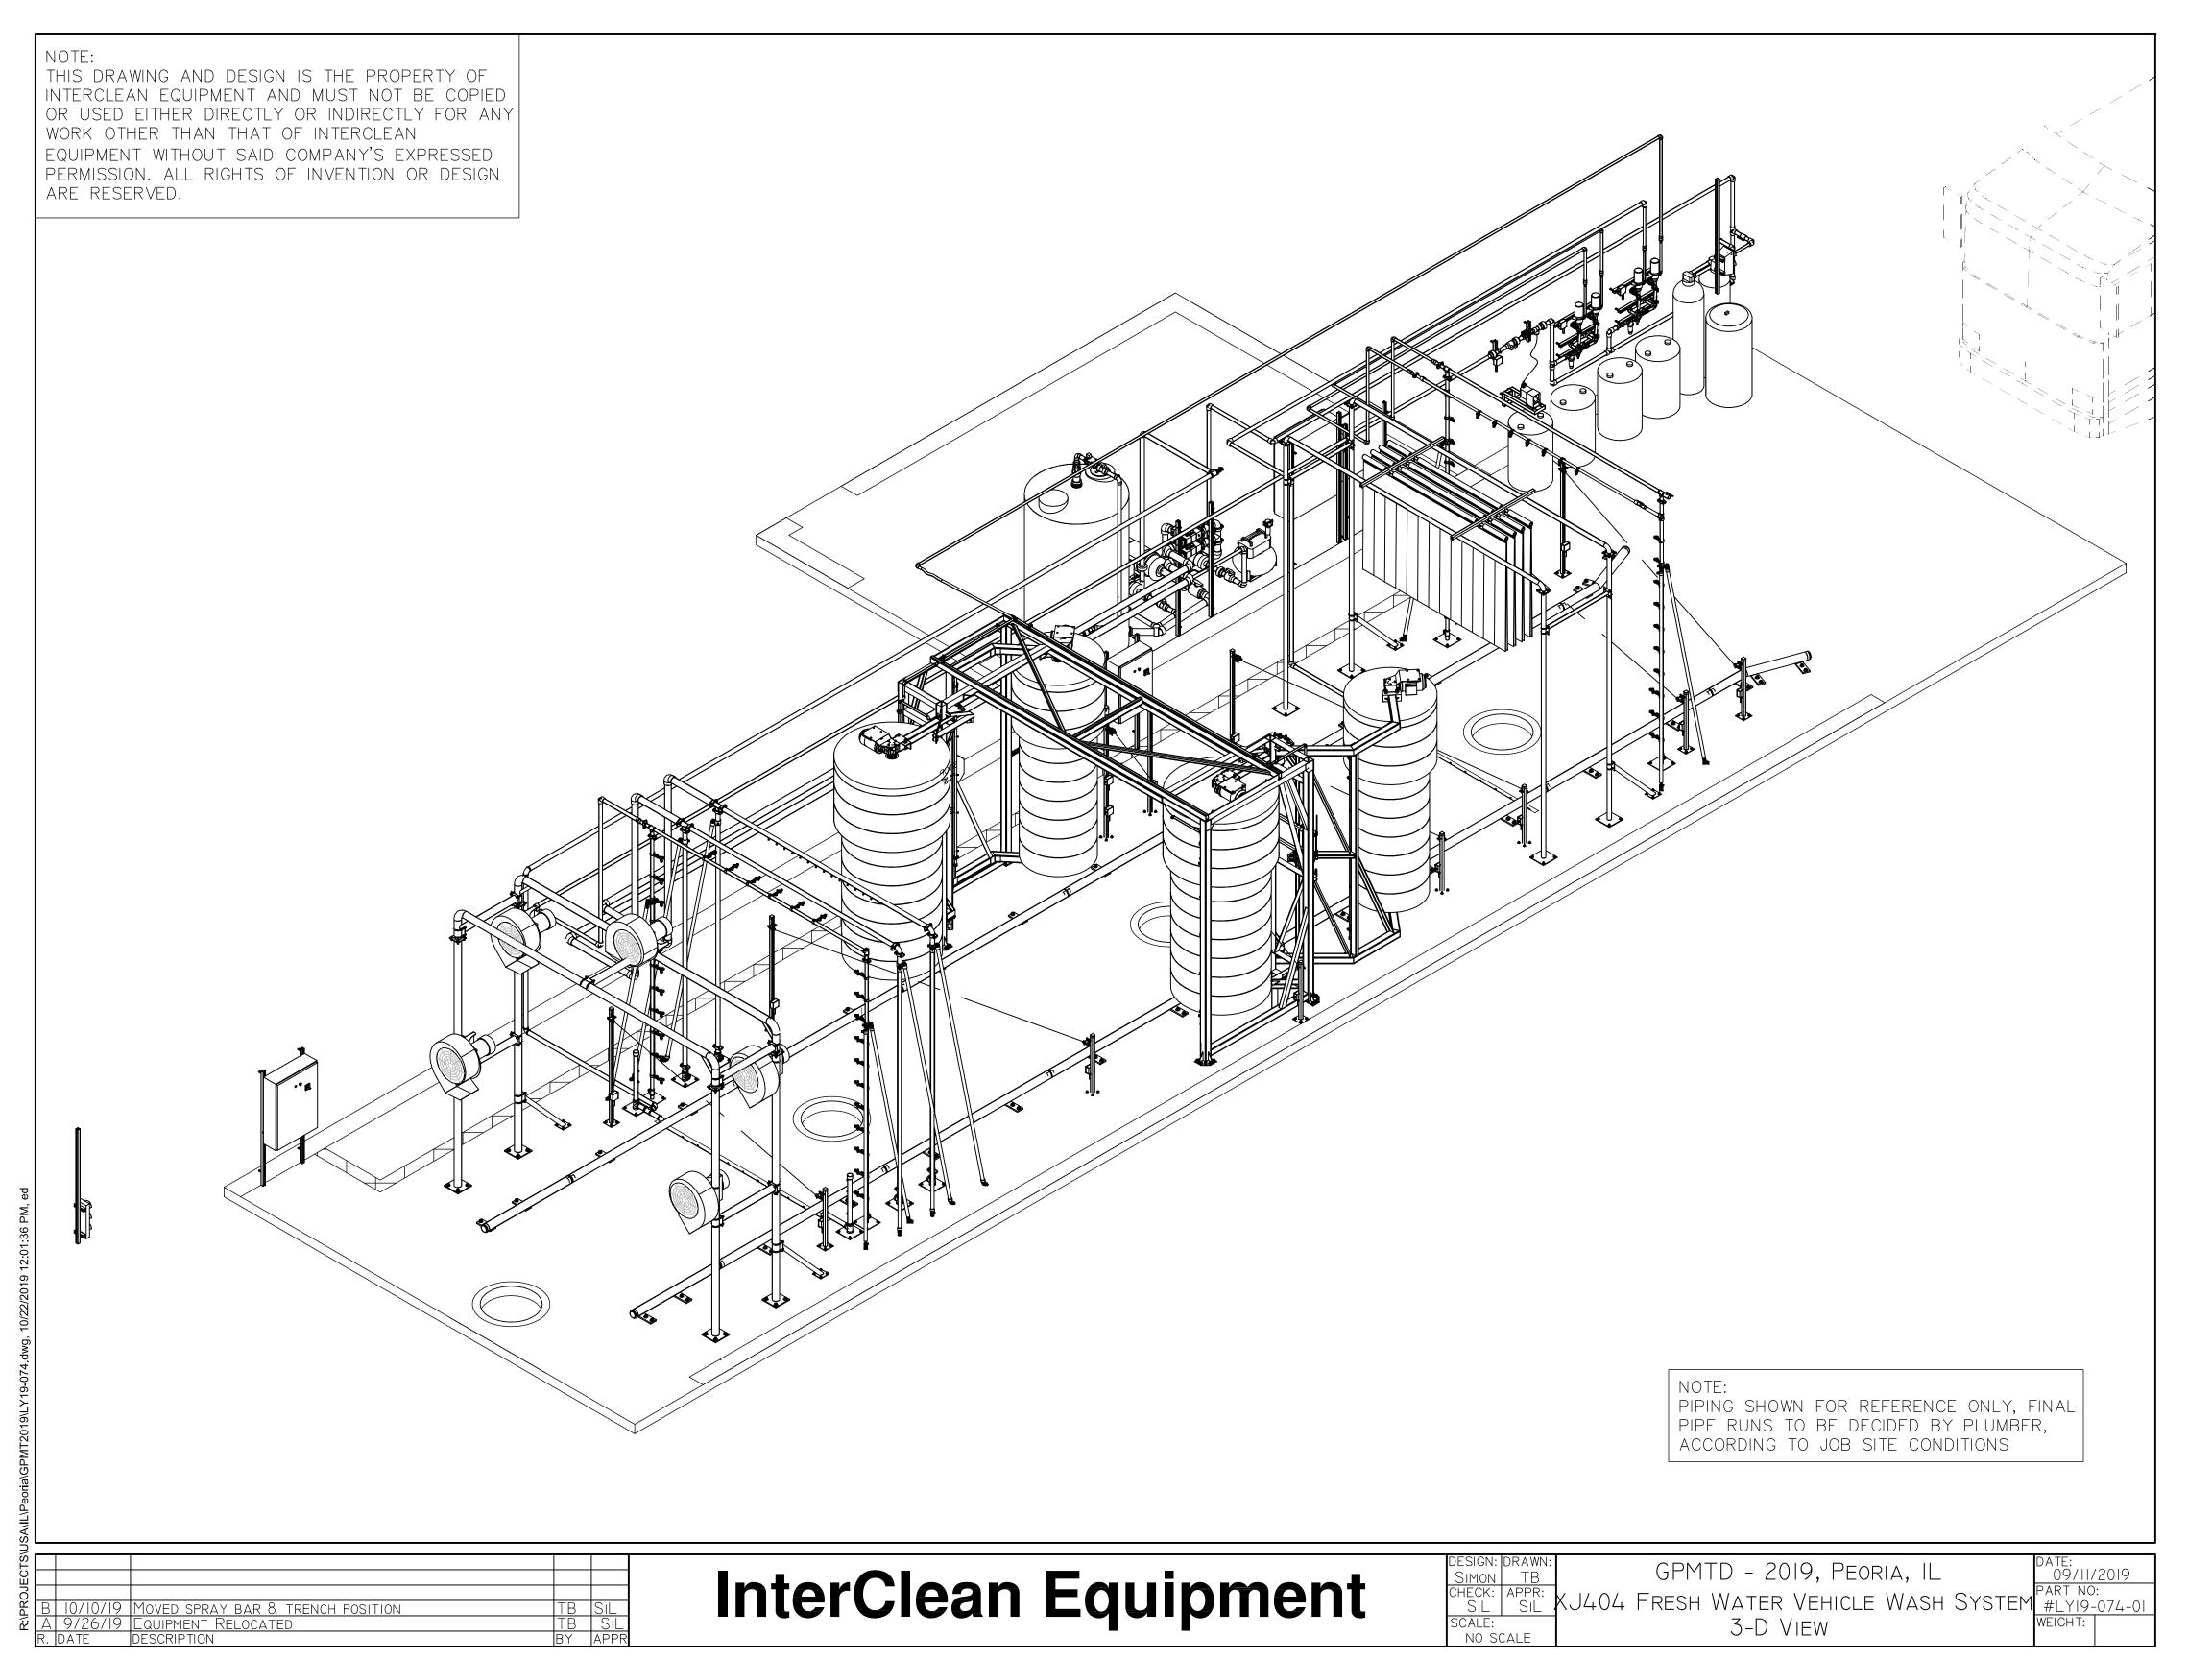
В	10/10/19	Moved chassis spray bar & trench	ТВ	SıL
А	9/26/19	EQUIPMENT RELOCATED	ТВ	SıL
R.	DATE	DESCRIPTION	BY	APPR

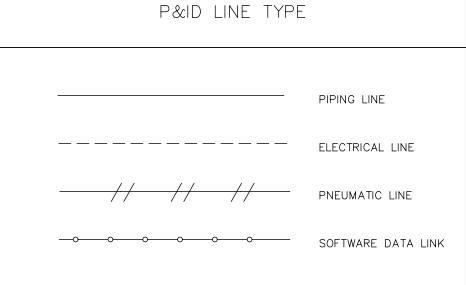InterClean Equipment

	DESIGN:	DRAWN:					
	SıL	TB					
	CHECK:	APPR:					
	SıL	SiL :					
SCALE:							
	No S	NO SCALE					

GPMTD - 2019, PEORIA, IL KJ404 FRESH WATER VEHICLE WASH SYSTEM #LY19-074-00 DRAWING INDEX

09/11/2019




NOTE: THE CONCRETE MUST CURE FOR 27 DAYS THIS DRAWING AND DESIGN IS THE PROPERTY OF INTERCLEAN EQUIPMENT AND MUST NOT BE COPIED BEFORE INSTALLING TIRE GUIDES OR USED EITHER DIRECTLY OR INDIRECTLY FOR ANY WORK OTHER THAN THAT OF INTERCLEAN EQUIPMENT WITHOUT SAID COMPANY'S EXPRESSED PERMISSION. ALL RIGHTS OF INVENTION OR DESIGN ARE RESERVED. 250 GAL. CHEMICAL TOTE SHOWN FOR REFERENCE ONLY (PROVIDED -BY CHEMICAL SUPPLIER) -25'-6"-BACK FLOW PREVENTER LOCATION SHOWN FOR REFERENCE -ONLY (PROVIDED BY GENERAL CONTRACTOR) B 03 26'-6"-**-**5'-5" **-**TRAFFIC DIRECTION 1'-3" 1'-6" -29'-7" REF DESIGN: DRAWN:
SIMON TB
CHECK: APPR:
SIL SIL
SCALE:
3/16"=1' GPMTD - 2019, PEORIA, IL


O9/11/2019
PART NO:
#LY19-074-02
PLAN VIEW

DATE:
09/11/2019
PART NO:
#LY19-074-02
WEIGHT: InterClean Equipment B 10/10/19 Moved spray bar & trench position
A 9/26/19 Equipment Relocated
R. Date Description Plan View



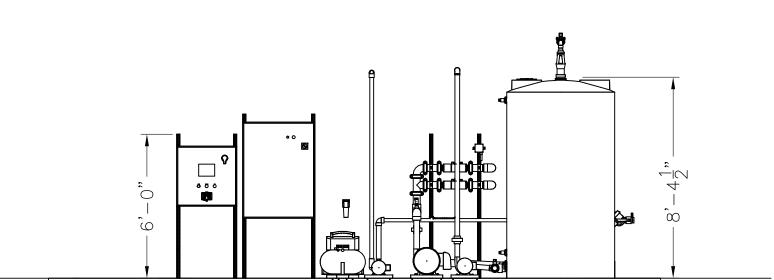

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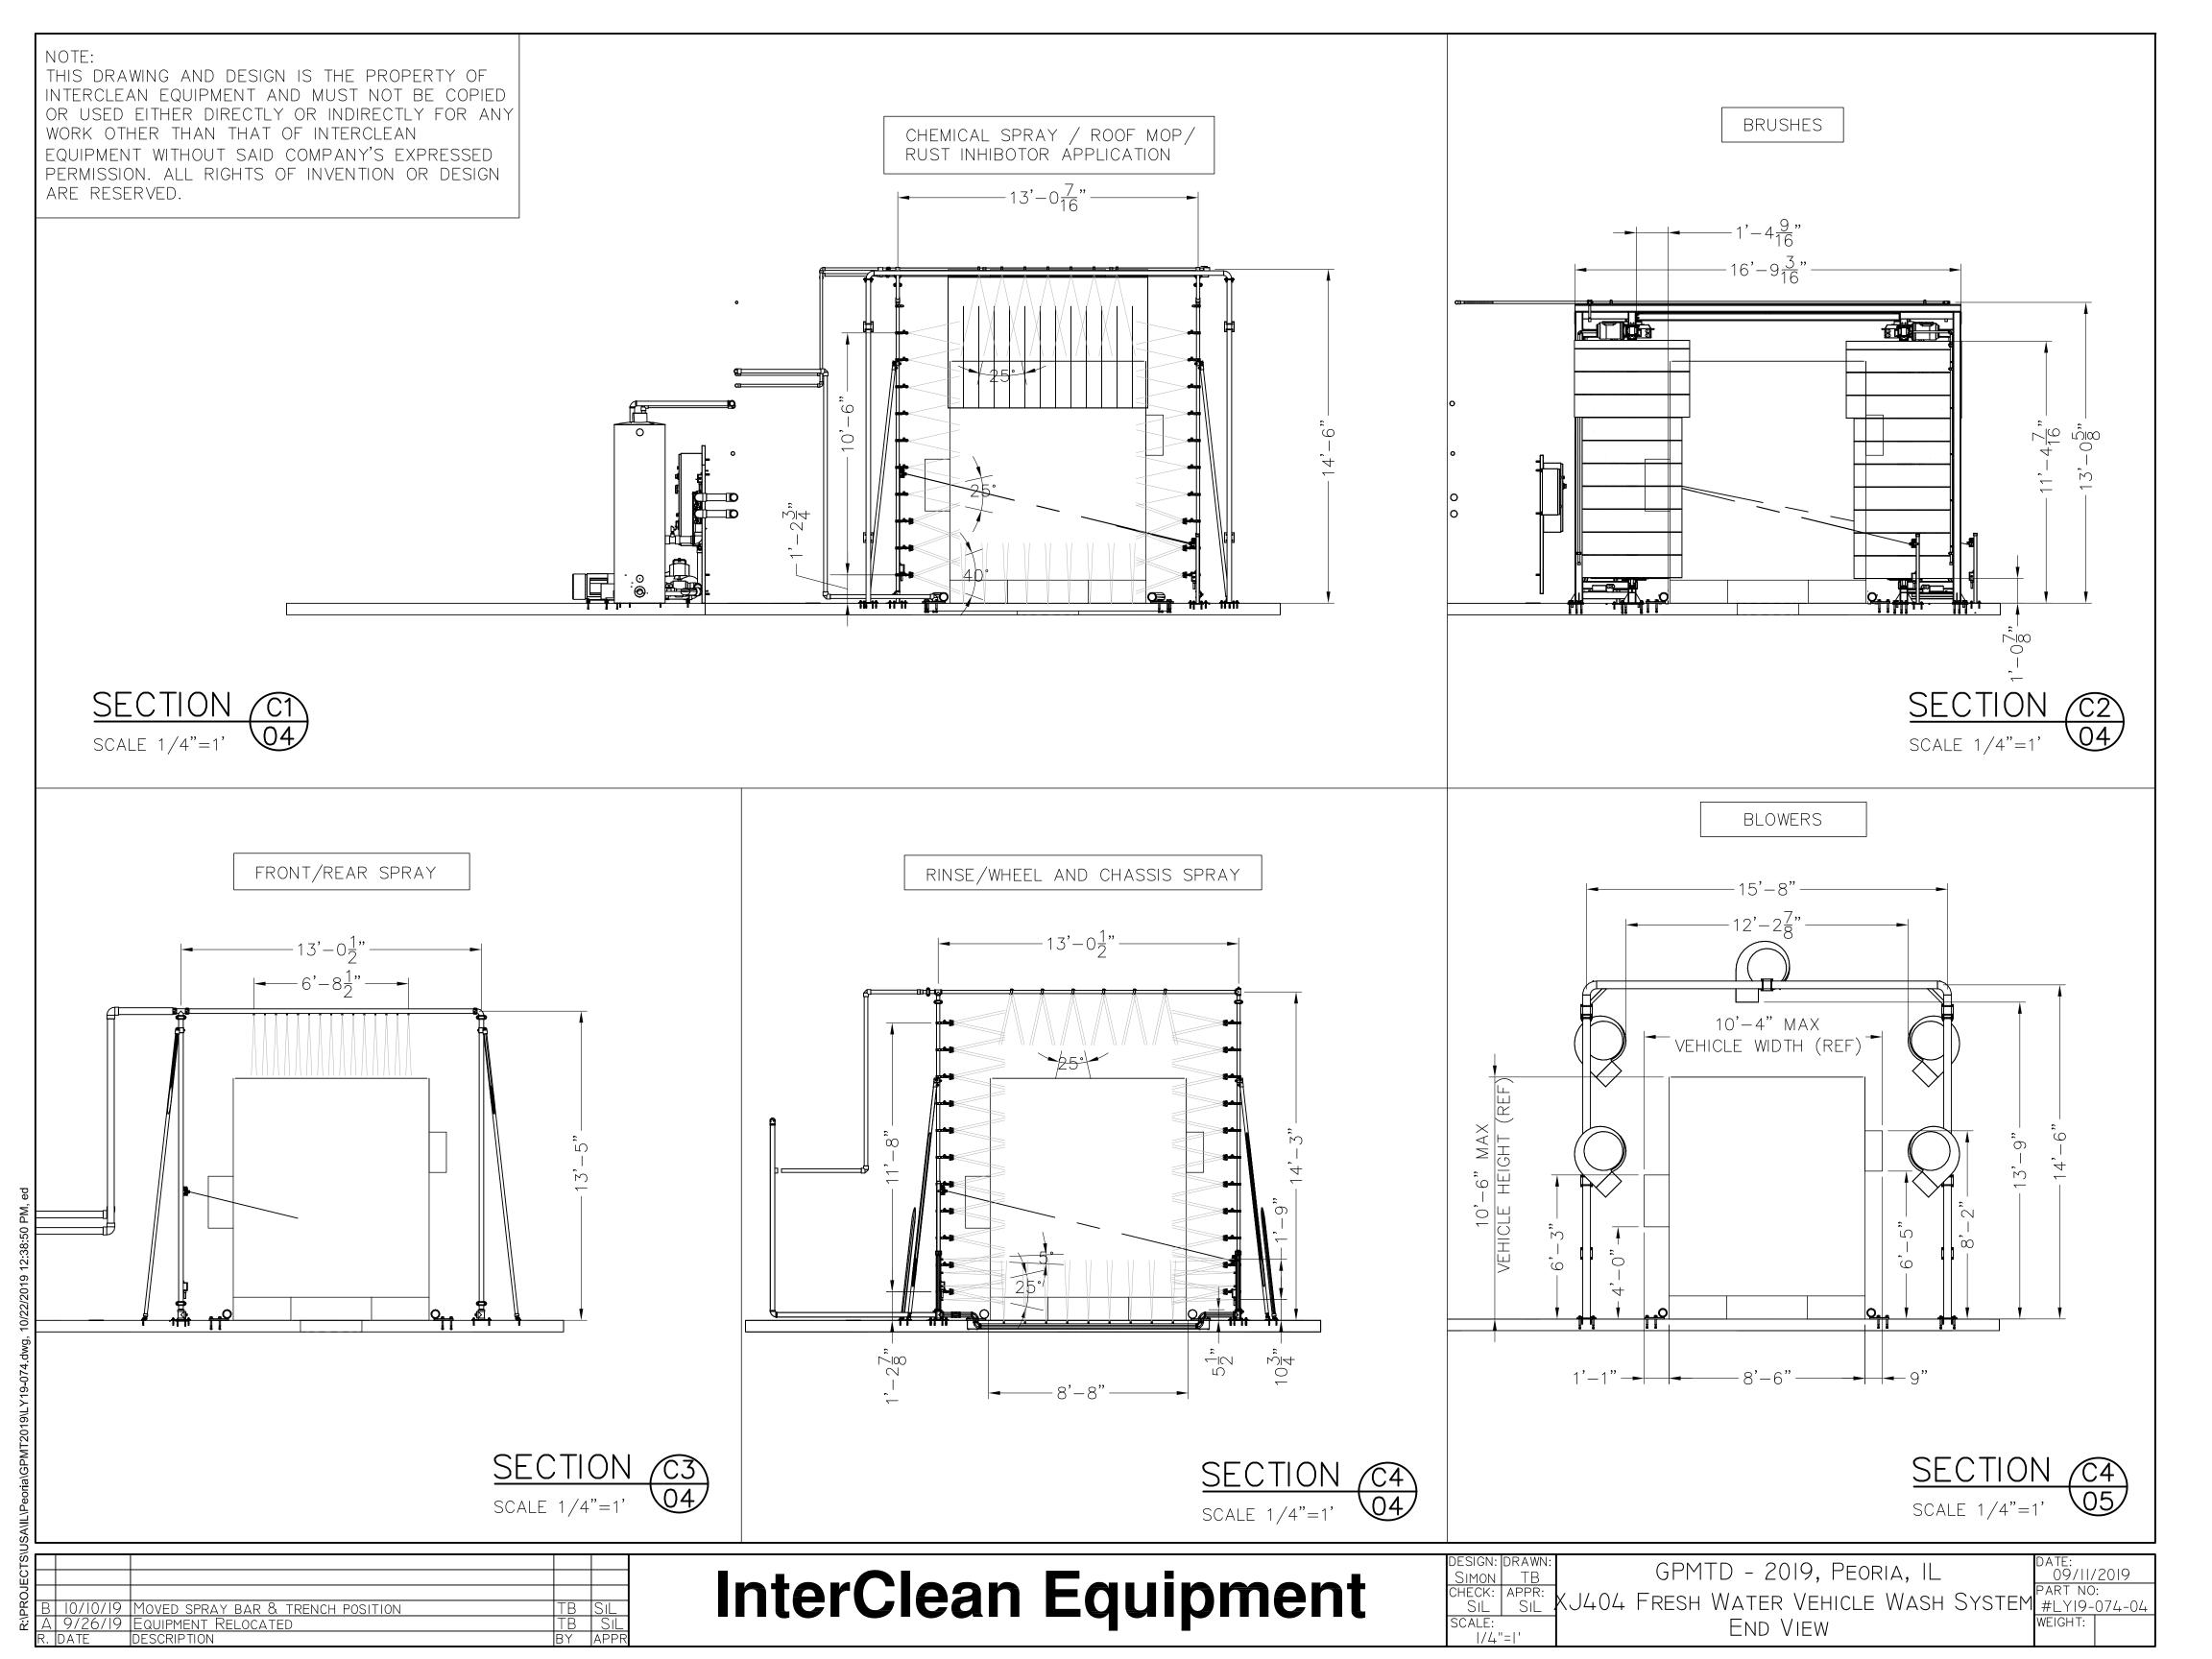
B 10/10/19 Moved spray bar & trench position
A 9/26/19 Equipment Relocated
R. Date Description

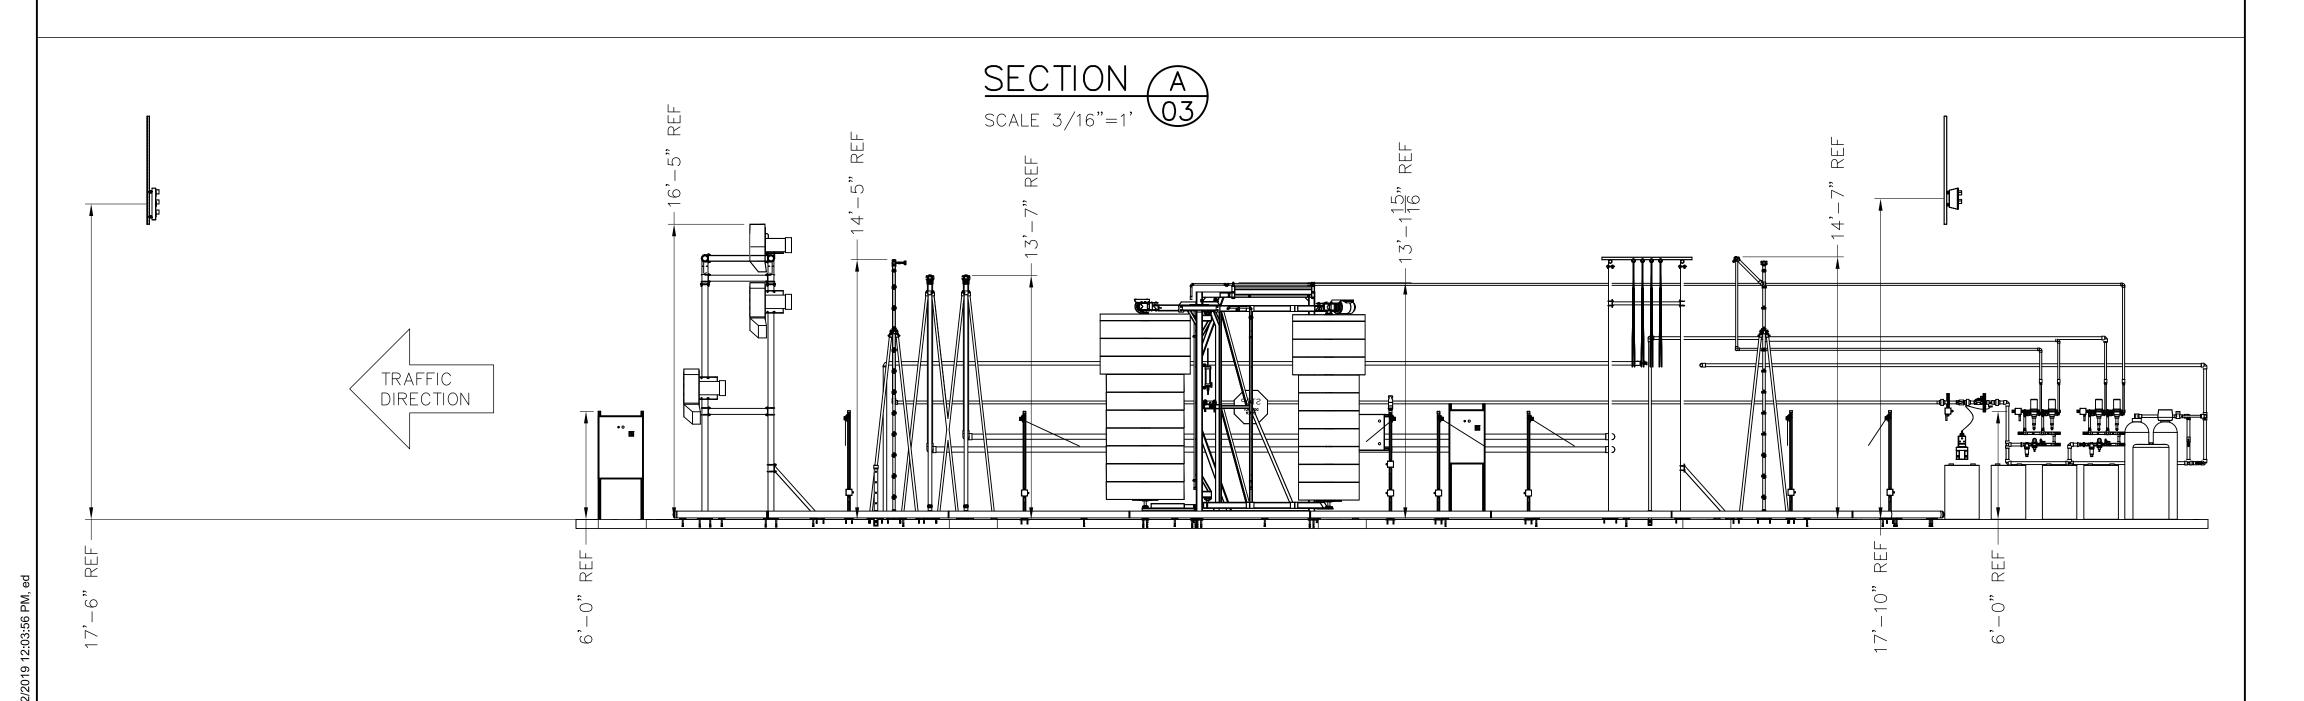
InterClean Equipment

DESIGN: DRAWN:
SIMON TB
CHECK: APPR:
SIL SIL
SCALE:
SCALE VARIES

GPMTD - 2019, PEORIA, IL

AUGUSTA STEAM CONTROL OF THE TOTAL CONTROL OT THE TOTAL CONTROL OF THE TOTAL CONTROL OF THE TOTAL CONTROL OT THE TOTAL CONTROL OF THE TOTAL CONTROL OF THE TOTAL CONTROL OT SIDE VIEW



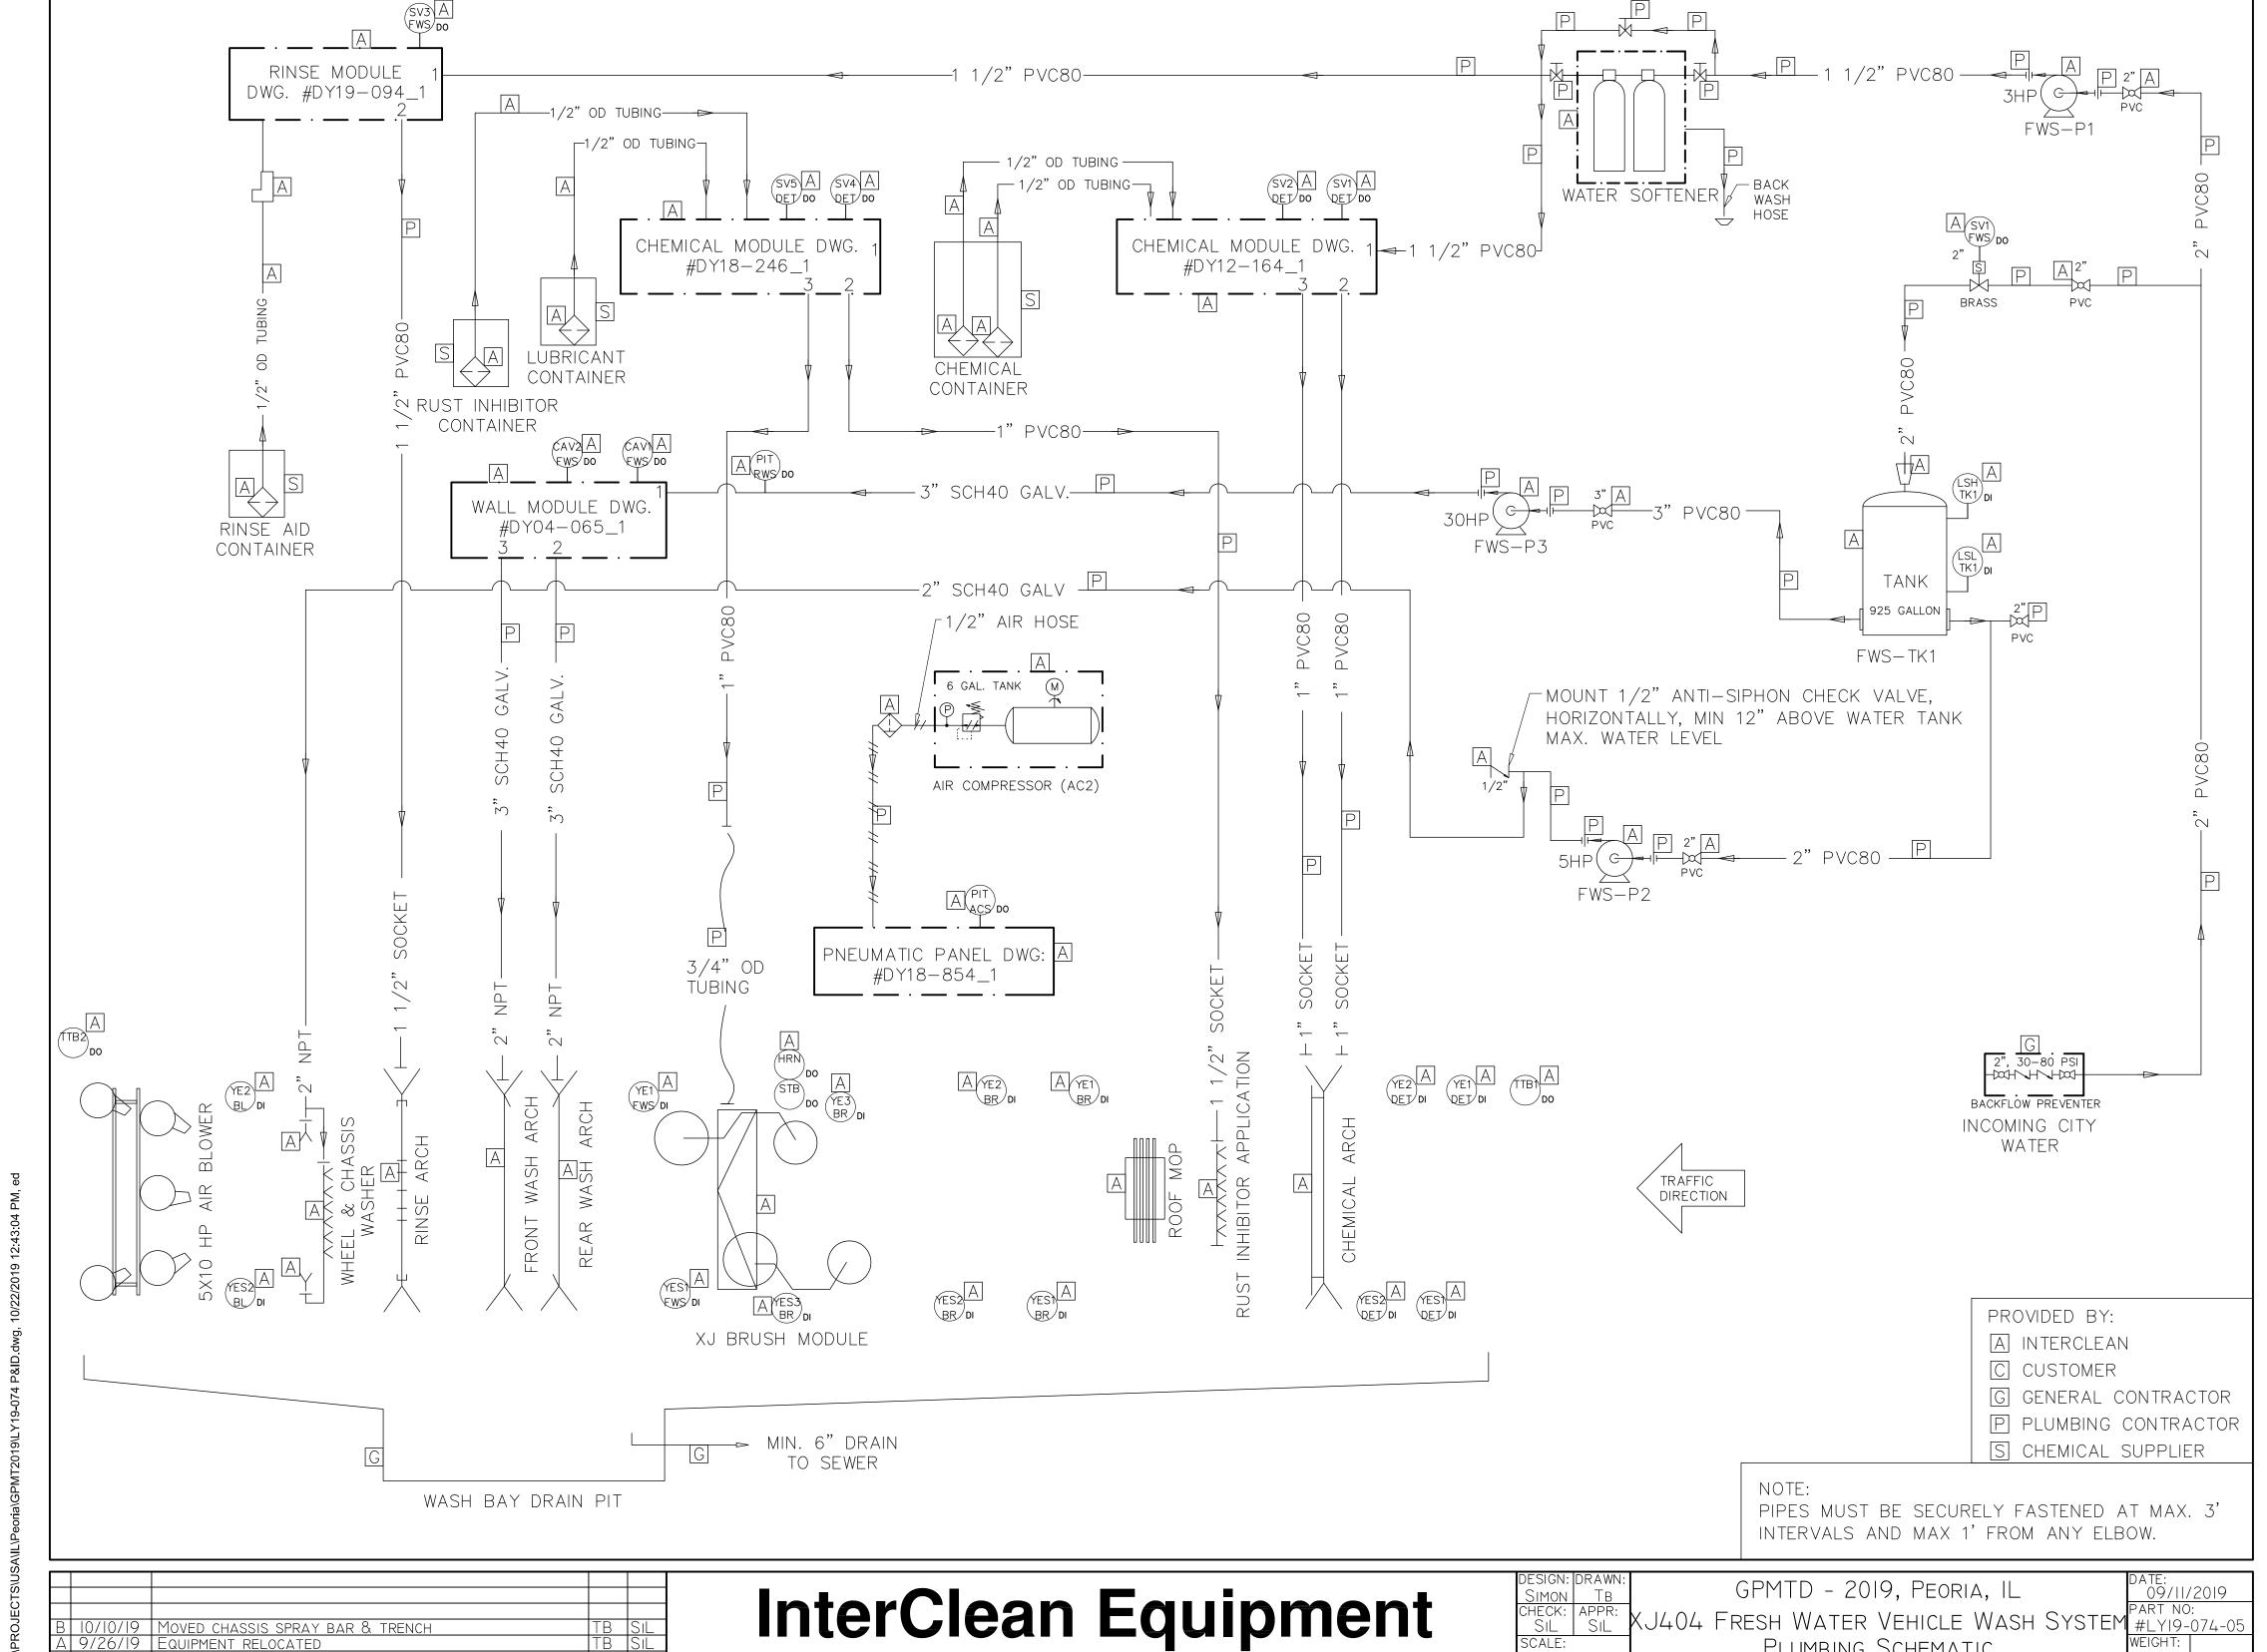



DATE DESCRIPTION

InterClean Equipment

SCALE: NO SCALE

PLUMBING SCHEMATIC

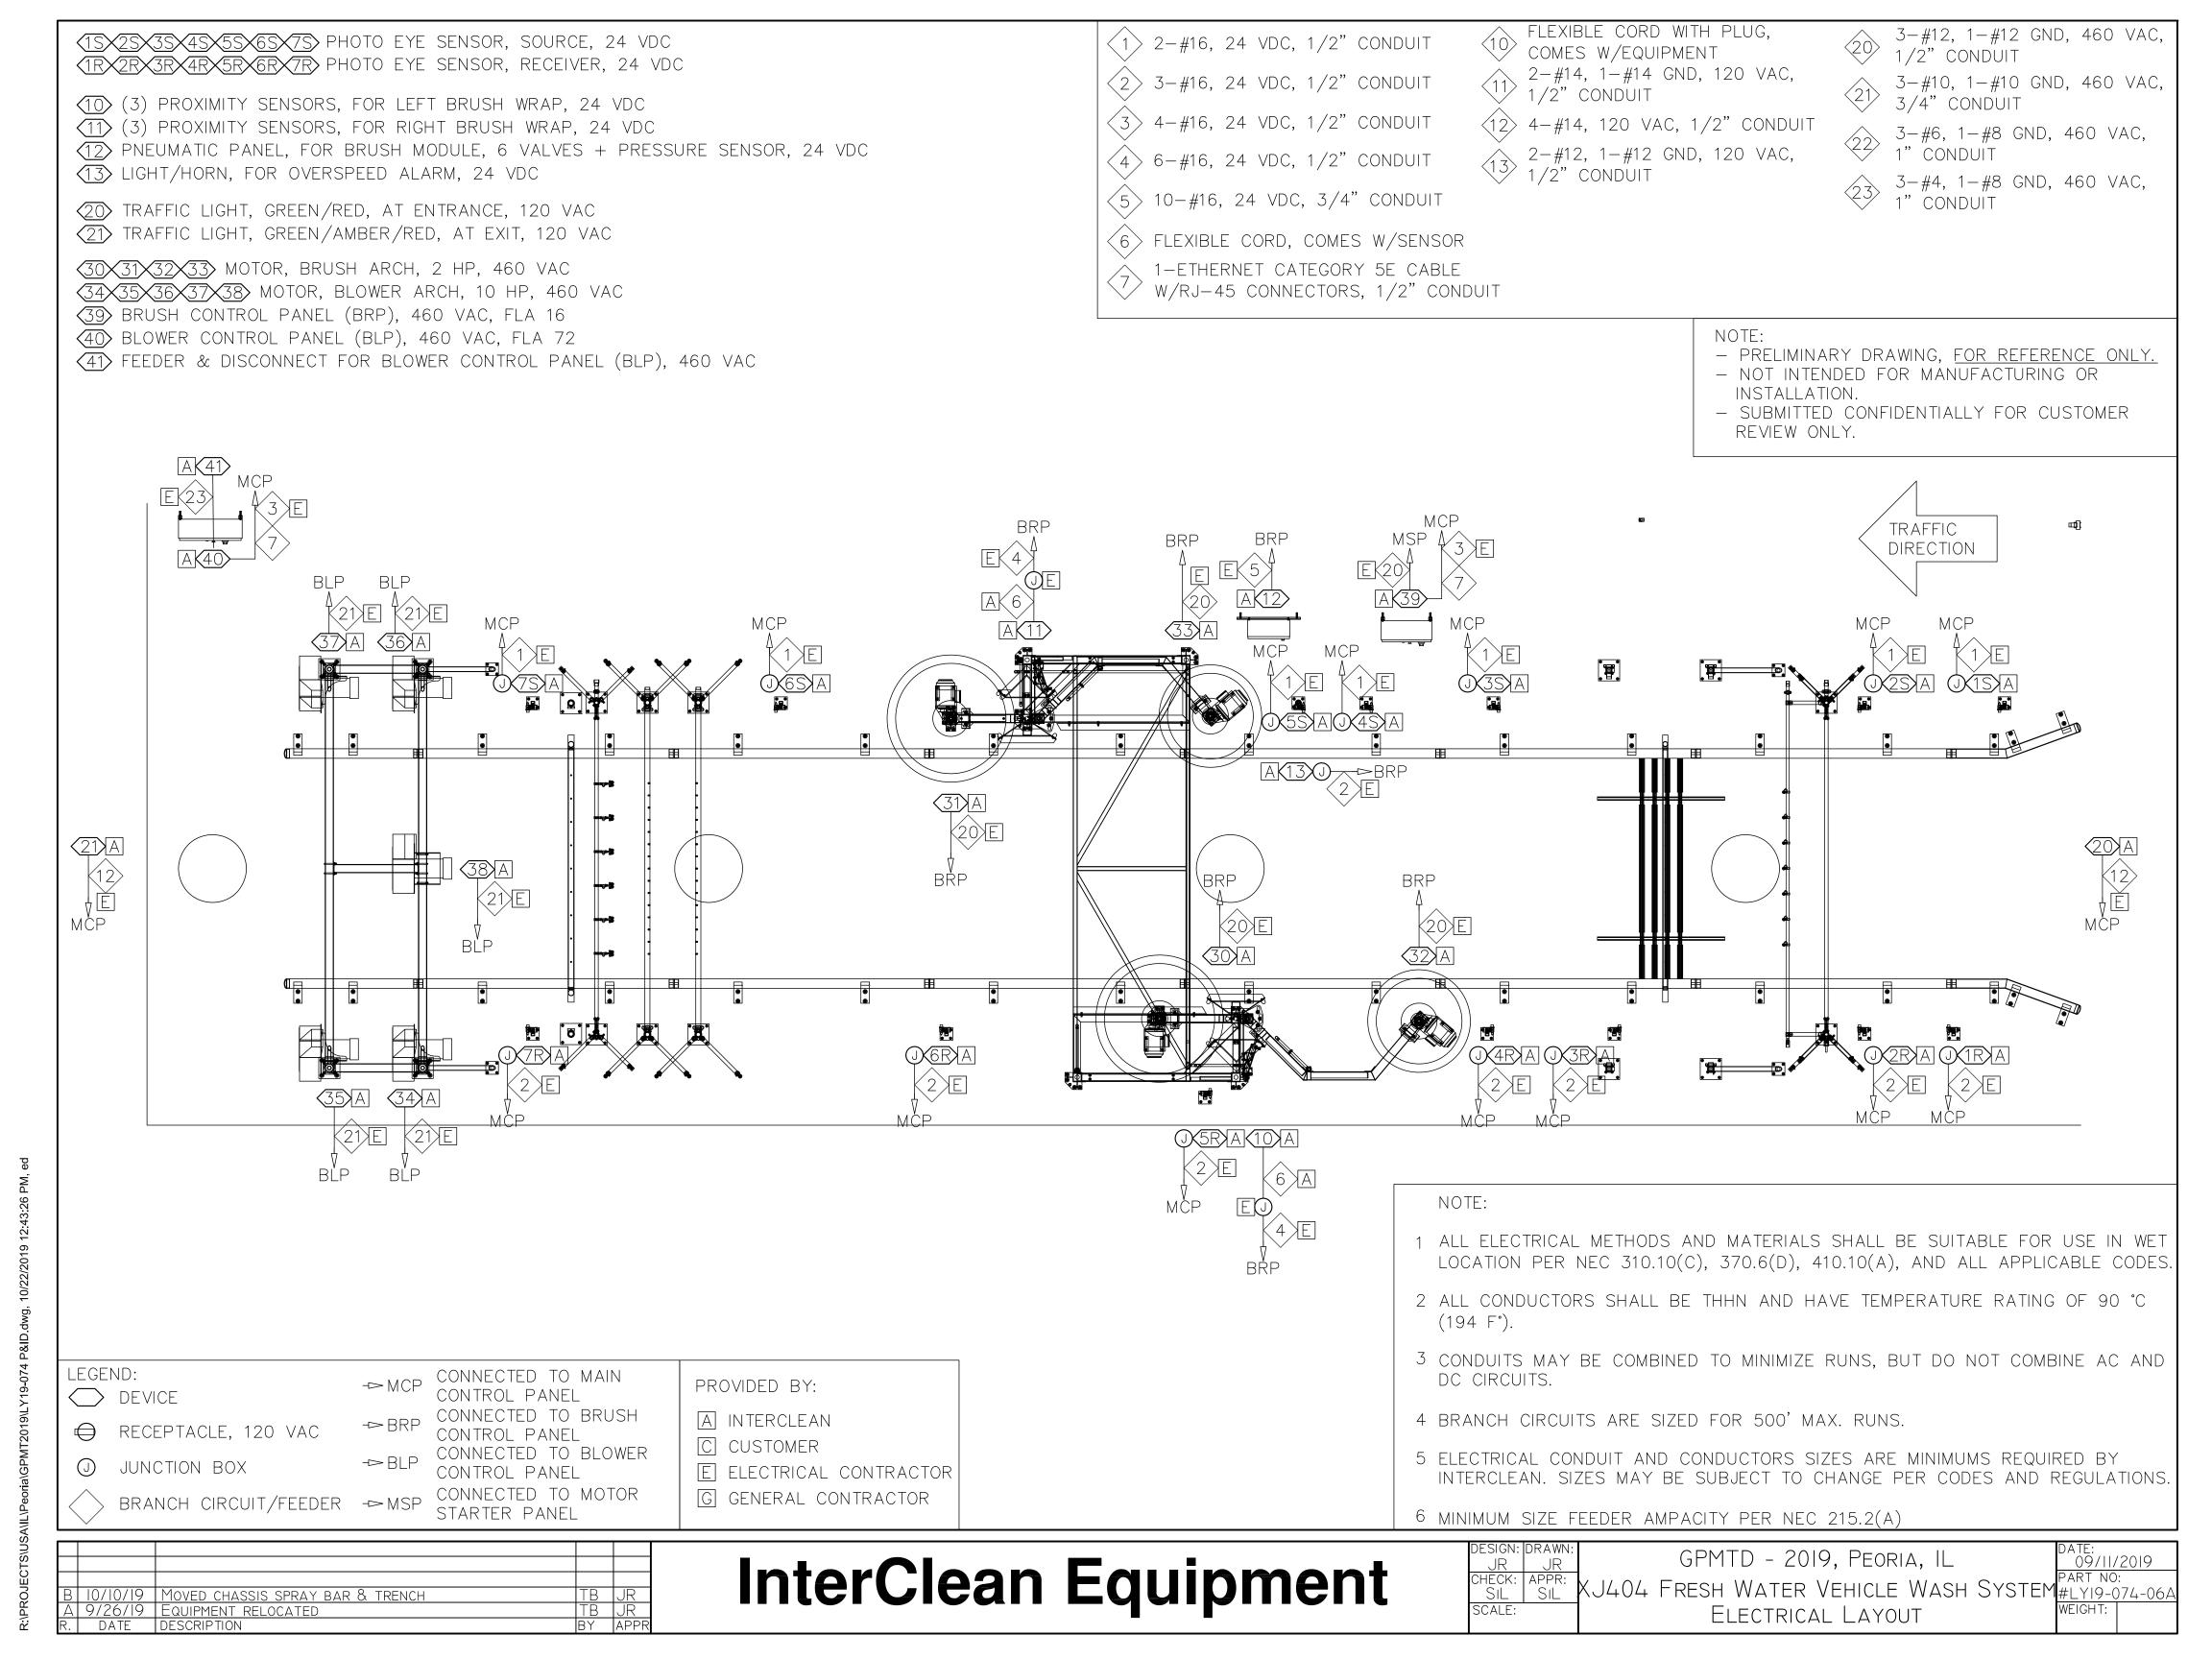

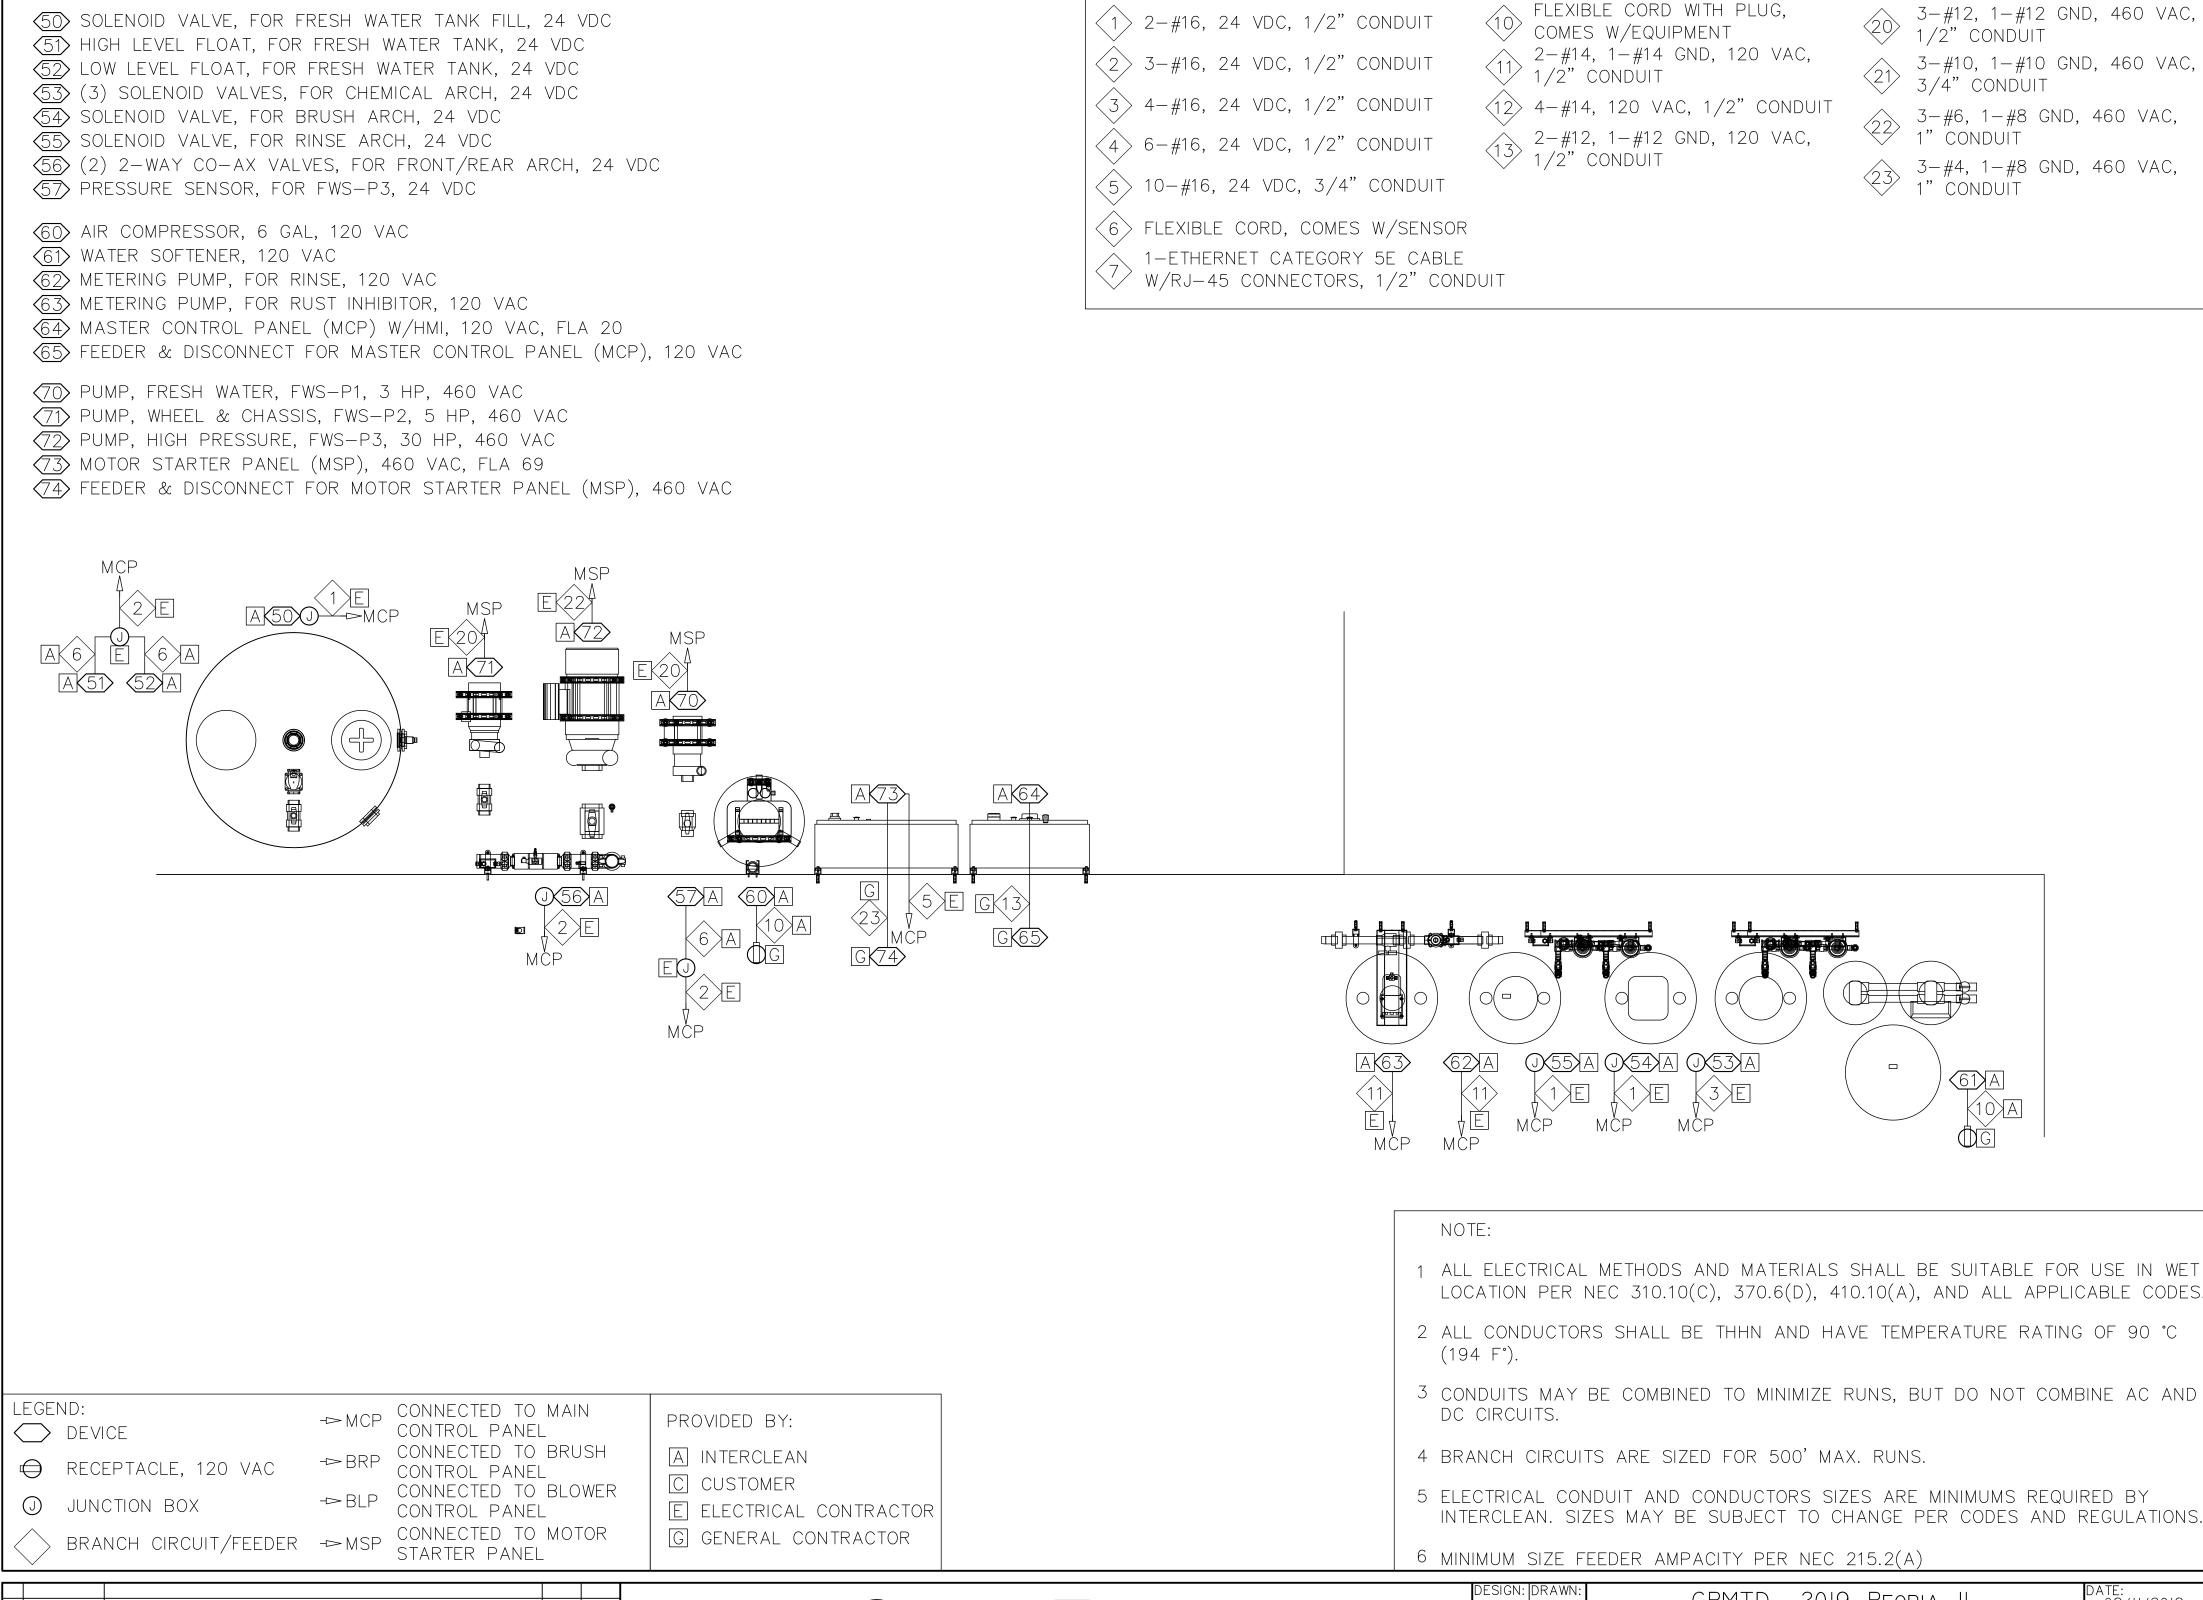

GPMT2019\LY19-074 P&ID.dwg, 10/22/2019 12:43:42 PM,

<u>0/19 | Moved chassis spray bar & trench</u>

<u> 4 9/26/19 | Equipment relocated</u>

InterClean Equipment

SIL SCALE:

GPMTD - 2019, PEORIA, IL KJ404 Fresh Water Vehicle Wash System#Lyi9-074-06e EQUIPMENT ROOM LAYOUT

09/11/2019

Parts List											
ITEM QTY	PRODUCTID	PRODUCTNAME	DRAWINGFILENAME	ITEM	QTY	PRODUCTID	PRODUCTNAME	DRAWINGFILENAM			
1 1	#DY13-571_1	Air Compressor Ass'y, 6 Gal., 2.6CFM@90 psi, 120v	AC11511-00	24	1 :	#DY18-840_1	Motor Starter Panel, Field Ass'y, Nema 4, 460v/60Hz	EP2411123-00			
2 2	#DY10-066_1	Arch Ass'y, Top Front/Top Rear, Galv., 15x0560, W=13', H=13'-5"	AR31262-03	25	1 :	#DY18-854_1	Pneumatic Panel Ass'y, for 6 Valves, XJ—Brush Frame Mnt	EP3212-06			
3 1	#DY00-210_1	Arch Ass'y, Chem., S.S., for Truck Wash, Side & Rear	AR322252-00	26	1	#DY19-094_1	Wall Module Ass'y, Rinse, One Outlet, w/Chem. Inject Point	MW3121-01M			
4 1	#DY00-218_1	Arch, Rinse, S.S., for Truck Wash, W=13', H=14'3"	AR322352-00	27	1	#DY04-065_1	Wall Module Ass'y, 3" Outlets, (2) 2-Way Co-Ax Valves	MW51312-00			
5 1	#DY19-828_1	Premier Blower Ass'y, Galv. Frame, 5x10Hp, 460V, 60Hz, H=13'-9" CLE	BLc41252-00	28	1 :	#DY15-458_1	Frame Ass'y, For Metering Pump, 304SS Frame & Hardware	MWa4221-00			
6 1	#DY15-289_1	Roof Mop, Field Assembly, 4 Mops, B-Line Mnt, , H=6'	BM451-07	29	1	PU13a111-00	Pump, Metering, Pulsatron—E+, 115v, 130W, #LPH5SA—PTC3—XXX	PU13a111-00			
7 1	#DY15-290_1	Roof Mop Support Frame, Field Ass'y, 2" Galv.	BM4611-03	30	1	#DY17-230_1	Pump, Booster, Floor Mounted, 3Hp, 230/460V, Tefc, Weg Motor	PU22122321-01			
8 1	#DY13-606_1	XJ Brush Mod., 2 Side & 2 Rear, H=11'4", 4x2HP, 575v/60Hz, Galv	BMg11223-02	31	1	#DY18-011_1	Pump, Booster, Floor Mounted, 5Hp, 230/460V, WEG Motor, Gould	PU22132331-00			
9 1	CH21-5	Rinse Aid, InterShine Concentrate, 5 Gallon	CH21-5	32	1	#DY17-089_1	Pump, Booster, Floor Mnt, 30Hp, 460V, tefc(weg), Goulds	PU22192311-01			
10 1	#DY15-090_1	Detergent, Hi-PH, 5 Gallon Container	CH6122-5	33	1	#DY12-164_1	Dosatron Pump (Aflas 1:20) Ass'y, 2 Pumps, Wall Mnt	PU23442-00			
11 1	CH621-5	Lubricant, 5 Gallon, Interpower Brush Lube	CH621-5	34	1	#DY18-246_1	Dosatron Pump Ass'y, (Aflas 1:50—1:500) , 2 Pumps, Wall Mnt	PU23442-04			
12 1	CHE1-4246-5	Cul-Mac Salt Block, 5gal	CHE1-4246-5	35	7	#DY08-433_1	Photo Eye Ass'y, Receiver, $H=3$ ', SS 304, Floor Mnt	SE3211211-00			
13 1	CO161E-00	Fixed Air Gap, Inlet 2", Outlet Threaded 3", Cast Iron	CO161e-00	36	7	#DY08-342_1	Photo Eye Ass'y, Sender, H=6', SS 304, Floor Mnt	SE3212212-00			
14 2	CO2111-2	Valve, Ball, 2", Compact, Socket, EPDM 0—Ring Seals	CO2111-2	37	1	#DY15-119_1	Softener Ass'y, w/Salt & Test Kit, 1.5", Max.43 GPM	S0622-00			
15 1	CO2111-3	Valve, Ball, 3", Socket, Fixed, EPDM O-Ring Seals	CO2111-3	38	1	#DY08-046_1	Tank, 925 Gal., Field Ass'y, 2 Outlets/2 Float Level Switches	TA2112-20			
16 2	CO2112-200	Valve, Ball, PVC, Socket, Union, 2 "Spears	CO2112-200	39	1	#DY17-547_1	Traffic Light, Red/Green, Ceiling Mnt, Galv. Frame, 120—277VAC	TC331422-00			
17 1	CO2221-32D	Valve, Solenoid,. 2", NPT x NPT, Brass, Slow Closing, 24VDC	CO2221-32D	40	1	#DY17-605_1	Traffic Light, Red/Amber/Green, Ceiling Mnt, Galv. Frame, 120—277VAC	TC331423-00			
18 1	CO2231-050	Valve, Swing Check, 1/2" F.NPT, Bronze	CO2231-050	41	1	#DY18-501_1	Light/Alarm, Field Assembly, PhotoEye Mounted, For Overspeed	TC3353-00			
19 1	#DY14-789_1	Pressure Sensor Assy, —14.5 to 362 psi, 1/4" npt, w/10m Cable	COb43424-00	42	1	#DY06-175_1	Tire Guides, CTW, Galv., L=71', OD=4.5", H= 5.5"	TGa141-70			
20 1	#DY11-514_1	Air Filter Ass'y, 1/2", Max. 140 CFM, w/Mnt Bracket	COk3321-00	43	1	#DY10-103_1	Under Chassis Spray Bar Ass'y, 2" Pipe, w/9x2560 HU Nozzles	UC11132-00			
21 1	#DY18-800_1	Master Control Panel, Standard, MCP120, Nema 4, 120v	EP1111113-00	44	1	#DY11-017_1	Under Chassis Spray Bar Ass'y, 1.5" SS304, w/9x4006 Noz.	UC11231-02			
22 1	#DY18-711_1	Slave Brush Panel, Field Ass'y, Nema 4X, 460V, BRP46042X	EP2211213-00	45	2	#DY10-049_1	Wheel Washer Ass'y, Floor Mnt, w/4x0530—Nozzles	WH311221-03			
23 1	#DY19-265_1	Blower Panel, Field Ass'y, Nema 4X, 460V, 60Hz, BLP460610X	EP2311222-00								
		(23)(5)(36)(43)(45)	36) (42) (8) (3)	6)(41	) (2	(27)(16) $(38)$ $(25)(22)(17)$	31 15 32 19 14 30 1 20 24 21 26 10 33 9	34) (11) (37)			

TRAFFIC DIRECTION (44)(35)(4)

NOTE:

ITEMS SPECIFIED AND DETAILS INDICATED MAY BE SUBJECT TO SUPERSEDING PER LOCAL CODES AND REGULATIONS

B 10/10/19 Moved spray bar & trench position
A 9/26/19 Equipment Relocated
R. Date Description

InterClean Equipment

SIMON TB
CHECK: APPR:
SIL SIL S
SCALE:
3/16"=1'

GPMTD - 2019, PEORIA, IL

O9/11/2019

XJ404 FRESH WATER VEHICLE WASH SYSTEM #LY19-074-07 EQUIPMENT LAYOUT

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NOTE:

ARE RESERVED.

WEIGHT:

